ALT 2- ROOF ADDITION & INTERIOR RENOVATIONS

ADDRESS:460-462 WEST BROADWAY NEW YORK, NY 10012

GENERAL NOTES

1. ALL CONTRACTORS AND SUBCONTRACTORS SHALL OBTAIN ALL REQUIRED PERMITS BEFORE THE START OF WORK AND SHALL OBTAIN ALL REQUIRED APPROVALS UPON COMPLETION.

2. THE CONTRACTOR SHALL GIVE ALL NOTICES AND COMPLY WITH ALL LAWS. ORDINANCES, RULES, CODES, AND REGULATIONS AND ANY PUBLIC AUTHORITY BEARING ON THE PERFORMANCE OF THE WORK AND SECURE ANY REQUIRED CERTIFICATES OF INSPECTION, TESTING, OR APPROVAL.

3. THE CONTRACTOR SHALL BE RESPONSIBLE FOR INITIATING, MAINTAINING, AND SUPERVISING ALL SAFETY PRECAUTIONS AND PROGRAMS IN CONNECTION WITH THE WORK. ALL NECESSARY SIGNS SHALL BE POSTED WARNING AGAINST

4. THE CONTRACTOR SHALL PURCHASE AND MAINTAIN SUCH INSURANCE AS WILL PROTECT HIM FROM CLAIMS WHICH MAY ARISE OUT OF OR RESULT FROM THE CONTRACTOR'S OPERATIONS UNDER THE CONTRACT.

5. THE CONTRACTOR SHALL INDEMNIFY AND HOLD HARMLESS THE OWNER AND ARCHITECT FROM ALL CLAIMS, DAMAGES, LOSSES, AND EXPENSES ARISING OUT OF OR RESULTING FROM THE PERFORMANCE OF THE WORK.

6. ALL CONTRACTORS AND SUBCONTRACTORS SHALL VERIFY CONDITIONS AND DIMENSIONS AT THE SITE AND SHALL INFORM THE ARCHITECT OF ANY AND ALL ERRORS, OMISSIONS, AND CLARIFICATIONS BEFORE THE START OF THE WORK.

7. ANY DEVIATION BETWEEN THE DIMENSIONS FURNISHED ON THE DRAWINGS AND ACTUAL FIELD DIMENSIONS SHALL BE THE RESPONSIBILITY OF THE CONTRACTOR.

8. THE CONTRACTOR SHALL BE RESPONSIBLE FOR ALL CONSTRUCTION MEANS, METHODS, TECHNIQUES, SEQUENCES, AND PROCEDURES AND FOR COORDINATING ALL PORTIONS OF THE WORK.

9. THE CONTRACTOR SHALL BE RESPONSIBLE FOR ALL THE CUTTING, FITTING, AND PATCHING THAT MAY BE REQUIRED TO COMPLETE WORK OR TO MAKE ITS SEVERAL PARTS FIT TOGETHER CORRECTLY.

10. ALL WORK SHALL BE PERFORMED BY SKILLED TRADESMEN AND SHALL BE PERFORMED IN A WORKMANLIKE MANNER IN ACCORDANCE WITH GENERALLY ACCEPTED STANDARDS.

11. ALL EQUIPMENT PROVIDED BY THE CONTRACTOR OR THE OWNER SHALL BE INSTALLED IN ACCORDANCE WITH THE MANUFACTURER'S INSTRUCTIONS.

12. WHERE THE CODE PRESCRIBES THE USE OF A PARTICULAR MATERIAL AND ALTERNATE MATERIALS ARE TO BE SUBSTITUTED. IT SHALL BE SHOWN TO BE EQUIVALENT TO THE SPECIFIED MATERIAL TO THE SATISFACTION OF THE COMMISSIONER OF BUILDINGS.

13. ALL ELECTRICAL WIRING AND CIRCUITRY SHALL BE THE RESPONSIBILITY OF THE ELECTRICAL CONTRACTOR. ELECTRICAL WORK SHALL COMPLY WITH NATIONAL AND LOCAL ELECTRICAL CODES, AND THE REQUIREMENTS OF THE LOCAL UTILITY COMPANY.

14. THE CONTRACTOR WARRANTS TO THE OWNER THAT ALL WORK WILL BE OF THE BEST QUALITY, FREE FROM FAULTS AND DEFECTS. ALL WORK SHALL BE GUARANTEED FOR ONE YEAR STARTING WITH THE DATE OF FINAL PAYMENT. DURING THE TIME THE CONTRACTOR SHALL MAKE GOOD ANY DEFECTS IN THE

PROJECT DIRECTORY

ARCHITECT:

dY-O design office **143 WEST 29 STREET** NEW YORK, NY 10001

CONTACT: STEFANO MORISI, R.A. A.I.A. POSITION: PRINCIPAL 1-917-960-3961 WWW.STUDIODYO.COM INFO@STUDIODYO.COM

BUILDING LANDLORD: CRISTINA CALORI CCNY REALTY, INC 444 MADISON AVE NEW YOR, NY 10022

INDEX OF SHEETS

	Sheet		Current	Current
ID	Number	Sheet Name	Revision	Revision Date
01	T-100.00	COVER SHEET	1	12/11/2023
02	G-100.00	GENERAL NOTES	1	12/11/2023
03	G-101.00	FIRE STOPPING DETAILS	1	12/11/2023
04	G-102.00	ADA NOTES & DETAILS	1	12/11/2023
04	G-103.00	LIFE AND SAFETY PLAN	1	12/11/2023
05	EN-100.00	ENERGY COMPLIANCE	1	12/11/2023
06	Z-100.00	GENERAL NOTES ZONING & LPC	1	12/11/2023
07	A-103.00	PROPOSED FIFTH FLOOR	1	12/11/2023
07	A-100.00	FIFTH FLOOR DEMO PLAN	1	12/11/2023
07	A-101.00	SIXTH FLOOR DEMO PLAN	1	12/11/2023
07	A-102.00	ROOF DEMO PLAN	1	12/11/2023
07	SP-100.00	5TH FLOOR PROPOSED SPRINKLER PLAN	1	12/11/2023
07	SP-101.00	6TH FLOOR PROPOSED SPRINKLER PLAN	1	12/11/2023
07	A-800.00	ROOFTOP RENDERS	1	12/11/2023
07	A-801.00	ROOFTOP RENDERS	1	12/11/2023
07	A-802.00	ROOFTOP RENDERS	1	12/11/2023
80	A-104.00	PROPOSED SIXTH FLOOR	1	12/11/2023
09	A-105.00	PROPOSED ROOF PLAN	1	12/11/2023
10	A-200.00	PROPOSED ELEVATIONS	1	12/11/2023
11	A-300.00	SECTIONS PROPOSED	1	12/11/2023
12	A-108.00	5TH FLOOR PROPOSED RCP	1	12/11/2023
12	A-109.00	6TH FLOOR PROPOSED RCP	1	12/11/2023
13	A-106.00	5TH FLOOR PROPOSED POWER PLAN	1	12/11/2023
AP3PI	LICABLE BUI	OTH FLOOR PROPOSED POWER PLAN	1	12/11/2023
14	A-500.00	DETAILS	1	12/11/2023
15	A-600,00 68 NEW YOR	SCHEDULES KSTATE BUILDING CODE. WHICH CONTAINS AMENDED VER	JION OF	12/11/2023
16	A-700.00	SIGHTLINE	1	12/11/2023
17	₩ 201 - 2014 B	APDING CODE	1	12/11/2023

17. 14PC - 2014 BLAPDING CODE 2. NYC - 2014 PLUMBING CODE 3. NYC - 2014 MECHANICAL CODE

- 4. NYC 2014 FUEL GAS CODE
- 5. NYC 2014 FIRE CODES
- 6. NYC ZONING RESOLUTION, 01-13-2014 7. NYC - 2020 ENERGY CONSERVATION CODE

PROFESSIONAL STATEMENT

(PER ECC 101.5.2.1)

"TO THE BEST OF MY KNOWLEDGE BELIEF AND PROFESSIONAL JUDGEMENT, THESE PLANS AND SPECIFICATIONS ARE IN COMPLIANCE WITH THE 2020 NEW YORK CITY ENERGY CONSERVATION CODE (NYCECC) CHAPTER C4."AS PER CH C5 OF THE 2020 ECCNY.

ASHRAE STANDARD 90.1 ENERGY CODE

TO THE BEST OF MY KNOWLEDGE, BELIEF AND PROFESSIONAL JUDGEMENT, THESE PLANS AND SPECIFICATIONS ARE IN COMPLIANCE WITH THE ASHRAE STANDARD 90.1 ENERGY CODE.

ARCHITECTURAL SYMBOL LEGEND









CENTERLINE





ELEVATION MARK











AERIAL VIEW

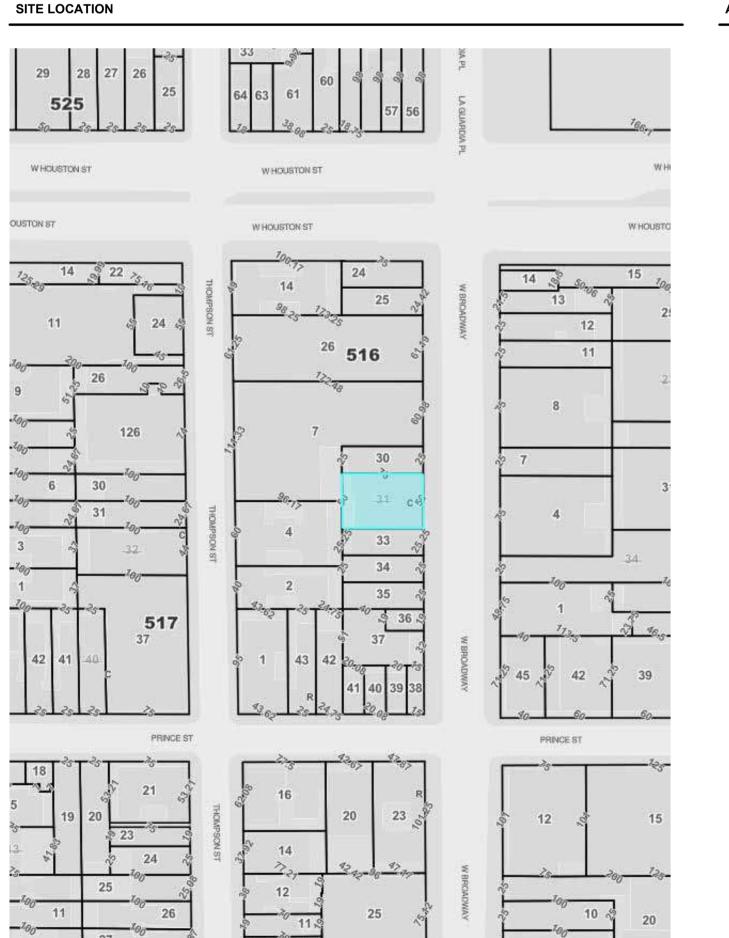

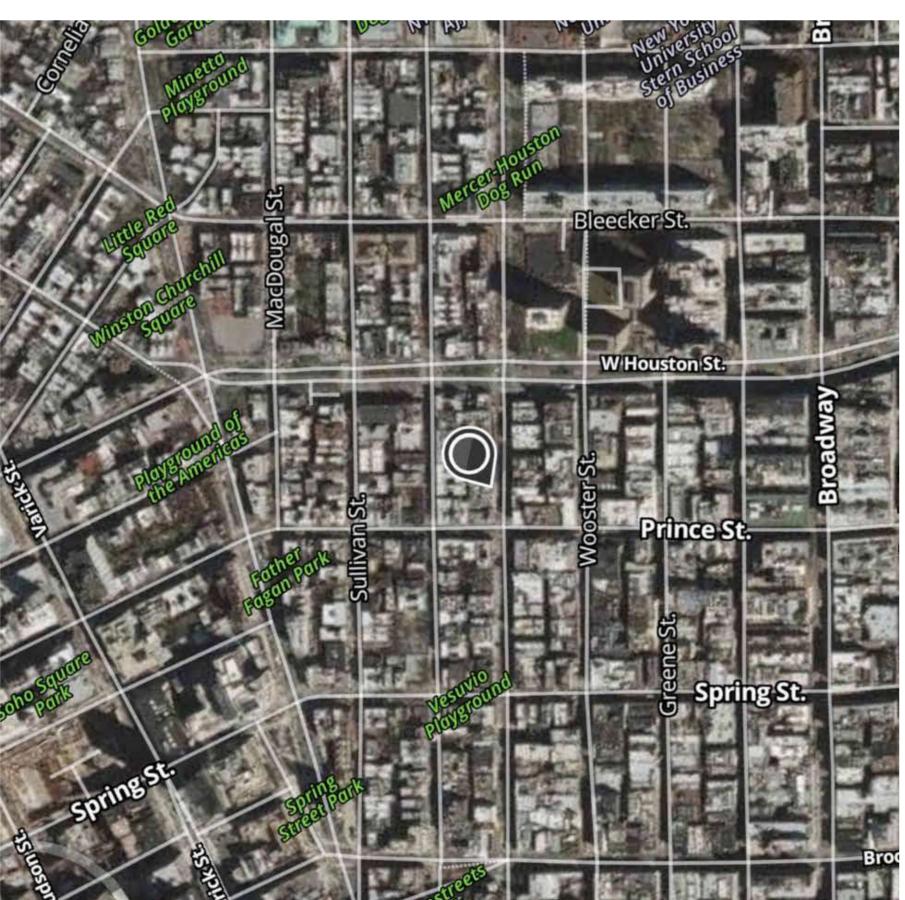

BUILDING INFORMATION

EXISTING

BLDG TYPE: MIXED RESIDENTIAL & COMMUNITY BOARD: MANHATTAN 10012

1087256 **ZONING MAP:** 12C LANDMARK BUILDING: L - LANDMARK

C OF O: MULTIPLE DWELLING CLASSIFICATION: OCC. CLASS (1968'):

> 1ST: RETAIL 2ND: ART GALLERY & JLWQA 3RD: JLWQA 4TH-5TH: OFFICE & JLWQA ZONING USE GROUP: M1-5A - LIGHT MFR DISTRICT

3, NON-FIREPROOF

HEIGHT: 5 STORIES (65')

ABBREVIATIONS

Pound OR Number High Point And HVAC Heating, Ventilating, Air Conditioning AD Area Drain INSUL Insulated or Insulation AFF Above Finished Floor INT Interior ALUM Aluminum Load Bearing LO ANOD Anodized BYND Beyond MAX Maximum BOT Bottom MO Masonry Opening MECH Mechanical CJ Control Joint CLG Ceiling MEMBR Membrane Clear Minimum CONT Continuous MTL Metal CTYD Courtyard NIC Not In Contract NLB DBL Double Non Load Bearing DEMO Demolish/Demolition NO Number On Center Diameter DIM PLUMB Plumbing Dimension DN PLYD Plywood Down DR Door PT **Pressure Treated** PNT Paint or Painted Drawing Each Roof Drain REQD Required

RM

SIM

Elevation Electrical EXIST Existing FXT Floor to Ceiling Height Floor Drain Floor to Sill Height FIXT Fixture GALV Galvanized

Top Of TYP Typical UNO Unless Noted Otherwise U/S Underside Verify In Field

Room

Similar

SPEC Specification

PROJECT INFORMATION

PROPOSED

MIXED USE COMM / RES


5 STORIES (65') + ROOF

SCOPE OF WORK: VERTICAL ENLARGEMENT OF EXISTING OFFICE IN 5-STORY BUILDING AT 462 WEST BROADWAY, NEW YORK. NEW USE TO BE OFFICE. EXISTING BUILDING IS JLQWA AS PER CO.

APPROVED DOB JOBS

120151904 SPRINKLER

ZONING MAP 12C

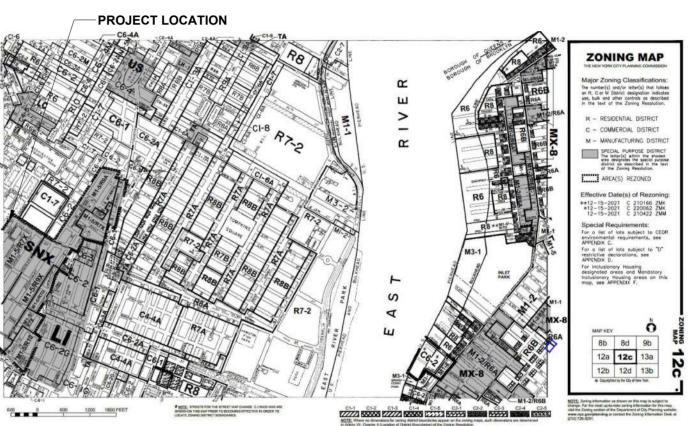

PLOT PLAN

75' - 0" **THOMPSON** LOT: 516 BLOCK: 7501/ $\mathbf{\Omega}$ 75' - 0"

PRINCE ST (50')

W HOUSTON ST (125')

PROJECT INFORMATION:

ADDRESS: 460-462 WEST BROADWAY NEW YORK, NY 10012

06/23/2022

GROSS FLOOR AREA: 15,204SF

ARCHITECT OF RECORD:

DY-O DESIGN OFFICE 143 WEST 29 STREET NEW YORK, NY 10001 SUITE# 902A

CONTACT: STEFANO MORISI R.A. T: 1-917-960-3961 E: INFO@STUDIODYO.COM

DESIGN ARCHITECT:

Architect Monica Cardin Fontana architetto@cardinfontana.it - www.cardinfontano.i

VIA MARCONI, 43 CASALECCHIO DI RENO, (BO) ARCHITETTO@CARDINFONTANA.IT WWW.CARDINFONTANA.IT

CRISTINA CALORI CCNY REALTY, INC. 444 MADISON AVE NEW YOR, NY 10022

DOB JOB #: 120070485

DISCLAIMER:

The architect shall not have control or charge of and methods, deviations, techniques, sequences or procedures, or for safety precautions and programs in connection with the work, for the acts or ommisions of the contractor, sub-contractors, or any other persons performing any of the work, or for the failure of any of them to carry out the work in accordance with the contract documents, written dimensions on this drawing shall have precedence over scaled dimensions. Contractors shall verify and be responsible for all dimensions and conditions on the job and this office must be notified of any variations from the dimensions and conditions shown by these drawings. shop details must be submitted to this office for review before proceeding with fabrication. not valid for construction unless signed and sealed by the architect and approved by the department of buildings.

SHEET TITLE:

COVER SHEET

SEAL AND SIGNATURE MM/DD/YYYY CHECKED BY DYO NO.

ADDRESS:	460-462 WEST BROADWAY
BLOCK	516
LOT	7501
COMMUNITY DISTRICT	MANHATTAN 10012
STREET TYPE	NARROW (70')
LANDMARK STATUS	YES
LANDMARK TYPE	HISTORIC DISTRICT
HISTORIC DISTRICT	SoHo-Cast Iron Historic District Extension
LPC DESIGNATION DATE	MAY 11,2010
LOT FRONTAGE	50'
LOT DEPTH	75'
LOT AREA	3750 SF
BUILDING FOOTPRINT	3750 SF
ZONING MAP	12C
ZONING	M1-5A - LIGHT MANUFACTURING DISTRICT (HIGH PERFORMANCE
SPECIAL ZONING	SoHo-NoHo Mixed Use District (SN

GENERAL ZONING NOTES

DISTRICT

Zoning Resolution Articles that apply to this project: Art.I Chapter 5: Residential Conversion within Existing Buildings Art.III Chapter 5: Bulk Regulations for Mixed Buildings in Commercial Districts

Multiple Dwelling law Article 277 (Residential conversion)

Mixed building (2/2/11): A "mixed building" is a #building# in a #Commercial District# used partly for #residential use# and partly for #community facility# or #commercial use#.

Enlargement, or to enlarge (2/2/11): An "enlargement" is an addition to the #floor area# of an existing #building#, an increase in the size of any other structure, or an expansion of an existing #use#, including any #uses accessory# thereto, to an open portion of a #zoning lot# not previously used for such #use#. To "enlarge" is to make an #enlargement#.

SoHo-NoHo Mixed Use District (SNX)

Extension, or to extend (12/15/61): An "extension" is an increase in the amount of existing #floor area# used for an existing #use#, within an existing #building#. To "extend" is to make an #extension#.

Height factor (3/22/16): The "height factor" of a #zoning lot# is equal to the total #floor area# of a #building# divided by its #lot coverage#.

Lot coverage (3/22/16): "Lot coverage" is that portion of a #zoning lot# which, when viewed directly from above, would be covered by a #building# or any part of a #building#. However, for purposes of computing a #height factor#, any portion of such #building# covered by a roof which qualifies as #open space#, or any terrace, balcony, breeze way, or porch or portion thereof not included in the #floor area# of a #building#, shall not be included in #lot coverage#.

Open space ratio (2/2/11): The "open space ratio" of a #zoning lot# is the number of square feet of #open space# on the #zoning lot#, expressed as a percentage of the #floor area# on that #zoning lot#.

"Floor area": is the sum of the gross areas of the several floors of a #building# or #buildings#, measured from the exterior faces of exterior walls or from the center lines of walls separating two #buildings#.


Floor area ratio (2/2/11): is the total #floor area# on a #zoning lot#, divided by the #lot area# of that #zoning lot#.

Yard (9/19/73): A "yard" is that portion of a #zoning lot# extending open and unobstructed from the lowest level to the sky along the entire length of a #lot line#, and from the #lot line# for a depth or width set forth in the applicable district #yard# regulations. Where a #street setback line# is shown on the City Map the #yard# extends along the entire length of the #street setback line#, and from the #street setback line# for a depth or width set forth in the applicable district #yard# regulations.


32-10 Uses Permitted as-of-right 32-11 - Use Groups 1 and 2 in C1 C2 C3 C4 C5 C6

32-15 - Use Group 6 in C1 C2 C4 C5 C6 C8

SOHO-CAST IRON HISTORIC DISTRICT EXTENSION

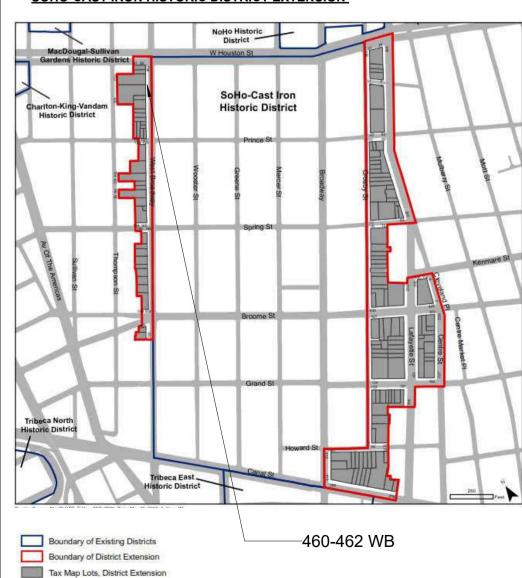

ZONING ANALYSIS ITEM/DESCRIPTION PERMITTED EXISTING PROPOSED COMPLIANCE NOTES USES RETAIL (CEL,1ST), JLWQA 42-131 USE GROUP # 6, 17D **COMPLIES** (2ND,3RD,4TH,5TH,6TH) FAR 43-12 FLOOR AREA (FAR=5) 18,750 17,341 18,016 COMPLIES MAX FA=5x3750= 18.750SF 43-12 18,750 17,341 17,341 MAX FOR ZONING LOT COMPLIES REMAINING FA= 1,409 SF LOT COVERAGE MIN INTERIOR LOT 43-17 3,600 3,750 N/A YARD PROVIDED REAR YARD AT MININUM REAR YARD **COMPLIES** 6TH FLOOR EXTENSION= ZR 143-23 (b) 23'-11" 23'-11" **HEIGHT & SETBACK** MINIMUM BASE HEIGHT ZR 143-24 (b) 60' 52' 52' MAXIMUM BASE HEIGHT 105' 52' 52' ZR 143-24 (b) ZR 143-24 (b) MAXIMUM BUILDING HEIGHT 145' 65' 65' 10' N/A 22'-5" ZR 23-662 (c) MINIMUM SETBACK DEPTH

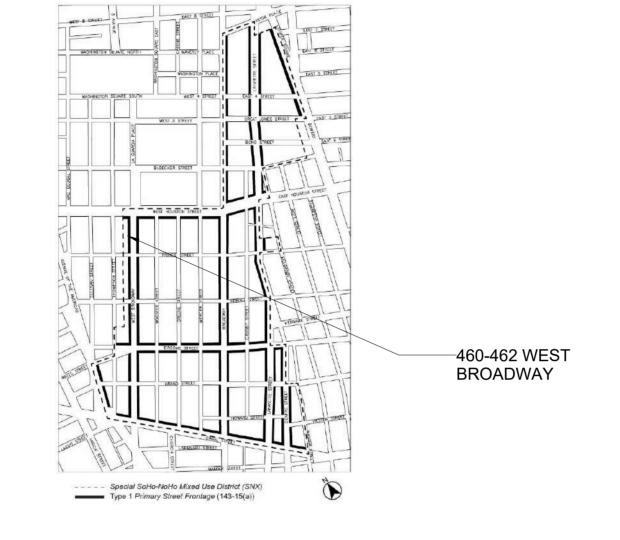

SPECIAL ZONING DISTRICT NOTES

Zoning Resolution Articles that apply to this project: **Article XIV: Special Purpose Districts** Chapter 3- Special SoHo-NoHo Mixed Use District (SNX)

ZR 143-00: General Purposes

ZR 143-07: Applicability of Quality Housing Regulations All buildings shall be developed or enlarged in accordance with the Quality Housing Program and the regulations of Article II, Chapter 8 shall apply. The bulk regulations of this Chapter shall be considered the applicable bulk regulations for Quality Housing

ZR 143-20: Special Bulk Regulations

Within the Special SoHo-NoHo Mixed Use District, the bulk provisions of Article XII, Chapter 3 are modified by the provisions of

ZR 143-23: Special Yard Regulations (b) Required rear yards

For all uses, a rear yard with a depth of not less than 20 feet shall be provided at every rear lot line on any zoning lot,

(3) for interior lots where the depth of such zoning lot, or a portion thereof, is less than 90 feet, and such shallow depth was in existence on December 15, 1961 and on the date of application for a building permit, the required rear yard for such interior lot, or portion thereof, may be reduced by six inches for each foot by which the depth of a zoning lot, or portion thereof, is less than 90 feet. However, in no event shall the minimum depth of a required yard, or portion thereof, be reduced to less than 10 feet.

ZR 143-24: Special Height and Setback Regulations

(b) Base heights and maximum building heights The table below sets forth the minimum and maximum base height, and maximum building height for all buildings.

A setback is required for all portions of a building that exceed the maximum base height specified for the applicable district and shall be provided in accordance with paragraph (c) of this Section.

AND MA	AXIMUM BUILDIN	IG HEIGHTS	
District	Minimum base height (in feet)	Maximum base height (in feet)	Maximum building height (in feet)
M1-5/R7D	60	105	115
M1-5/R7X	60	105	145
M1-5/R9A	60	125	175
M1-5/R9X, north of East Houston Street	60	125	195
M1-5/R9X, south of East Houston Street	85	145	205

However, for any zoning lot located in a Historic District designated by the Landmarks Preservation Commission, the minimum and maximum base heights may be modified as follows:


(1) the minimum base height of a street wall may vary between the minimum height set forth in the table above, and the height of the street wall of an adjacent building before setback, if such height is lower than the minimum base height; and


(2)the maximum base height of a street wall may vary between the maximum base height set forth in the table above, and the height of the street wall of an adjacent building before setback, if such height is higher than the maximum base height.


At a height not lower than the minimum base height or higher than the maximum base height specified for the applicable district in the table in paragraph (b) of this Section, a setback shall be provided in accordance with paragraph (c) of Section 23-662 (Maximum height of buildings and setback regulations) shall apply to such setbacks.


FLOOR AREA CALCULATION & MECHANICAL DEDUCTIONS


CELLAR FLOOR DOES NOT CONTRIBUTE TO FLOOR AREA

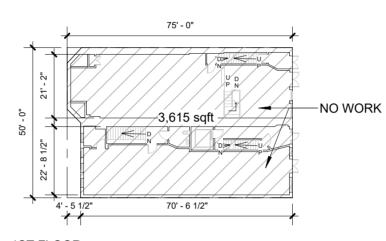


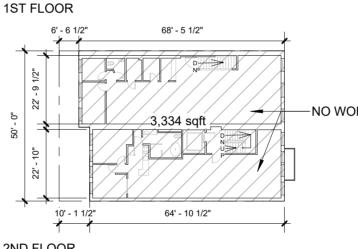

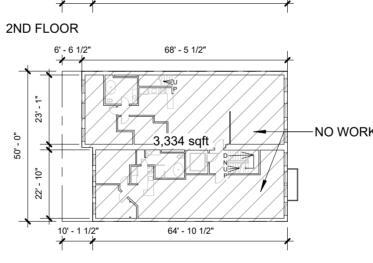

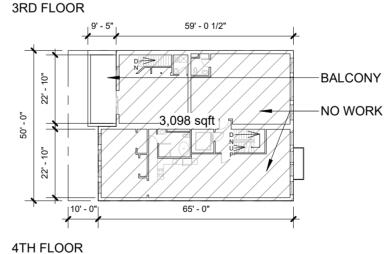

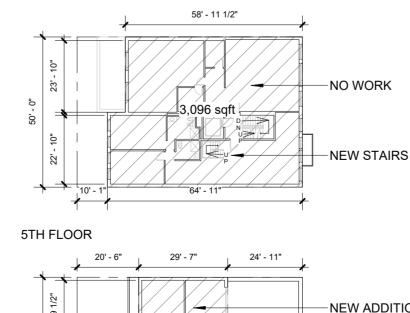

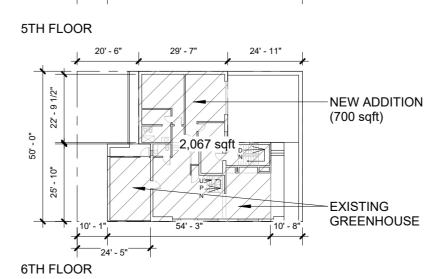

LANDMARKS PRESERVATION COMMISSION NOTES

APPROVED BY THE FULL COMMISSION

REAR YARD AND ROOFTOP ADDITIONS

- THE SCOPE OF WORK DOES NOT RESULT IN DAMAGE TO, OR THE DEMOLITION OF A SIGNIFICANT ARCHITECTURAL FEATURE OF THE HISTORIC BUILDING, SUCH AS A PITCHED ROOF, A HISTORIC DORMER
- OR SKYLIGHT X IS NOT VISIBLE FROM A PUBLIC THOROUGHFARE SCOPE OF WORK SHALL NOT AFFECT SIGNIFICANT ARCHITECTURAL FEATURES OF ADJACENT IMPROVEMENTS
- THERE ARE NO OUTSTANDING DOB OBJECTIONS FOR USE OF ROOF IS NO MORE THAN ONE STORY WITH A HEIGHT OF NO MORE THAN 11 FEET ABOVE THE ROOF OF THE STRUCTURE ON WHICH IT IS TO BE CONSTRUCTED
- STRUCTURE SHALL BE SET BACK AT LEAST 3 FEET FROM THE PLANE OF THE REAR FAÇADE
- IS NOT TO BE CONSTRUCTED ON A STRUCTURE WITH A GRANDFATHERED REAR YARD ADDITION OR ENLARGEMENT, A REAR YARD ADDITION OR ENLARGEMENT APPROVED BY THE LPC STAFF PURSUANT TO SECTION 2-16 OF THE LANDMARKS PRESERVATION COMMISSION'S RULES, OR A REAR YARD ADDITION OR ENLARGEMENT

QUALITY HOUSING NOTES

REFUSE STORAGE AND DISPOSAL ZR 28-12 NOT APPLICABLE, BUILDING HAS LESS THAN 9 DWELLING UNITS LAUNDRY FACILITIES

NOT MANDATORY/ NOT APPLIED ZR 28-14 DAYLIGHT IN CORRIDORS **EXISTING & PROPOSED CORRIDOR AT FIRST FLOOR**

RESIDENTIAL ENTRY HAS A GLAZED AREA OF 51SF > 20SF THUS IS DEDUCTED HALF OF THE AREA OF THE CORRIDOR REQUIRED RECREATION SPACE

NOT APPLICABLE, BUILDING HAS LESS THAN 9 DWELLING UNITSE ZR 28-23 PLANTING AREAS NOT APPLICABLE, EXISTING BUILDING IS A ZERO LOT BUILDING

DENSITY PER CORRIDOR NOT APPLICABLE, BUILDING HAS LESS THAN 9 DWELLING UNITS

NOTES

-THE FOLLOWING TABLE CALCULATES THE TOTAL PROPOSED FLOOR AREA ON

- AS PER ZR 111-20 (a) (11) THE MAXIMUM FLOOR AREA RATIO PERMITTED IS 5.0.

- ALL PARAPETS ARE 3'-6" HIGH THUS AS PER ZR 12-10 DEFINITION OF FLOOR AREA AT ITEM (10): THE PARAPETS DO NOT CONSTITUTE AN ENCLOSURE NO MORE THAN 67% OF THE PERIMETER OF SUCH BALCONY OR TERRACE ENCLOSED.

- D1 IS THE DEDUCTION FOR DAYLIGHT AS PER ZR 28-14.

- AS PER ZR 23-44 b(4) THE GREENHOUSE SHALL BE LIMITED TO AN AREA LESS THAN 25% OF THE REQUIRED REAR YARD. REQUIRED REAR YARD IS 28.92'. MAX AREA OF GREENHOUSE SHALL BE 137.4. PROPOSED GREENHOUSE IS 133SF < 137.4.

TOTAL = 90sf

-THE FOLLOWING TABLE CALCULATES THE TOTAL PROPOSED FLOOR AREA ON THE LOT.

- M1 THROUGH M6 REFERS TO MECHANICAL SPACE WHICH IS NOT INCLUDED IN THE CALCULATION OF FLOOR AREA AS PER ZR 12-10 DEFINITION OF FLOOR AREA WHERE DEDUCTION FOR MECHANICAL ALLOWED IS 50sf FOR THE FIRST UNIT AND 30sf FOR THE SECOND UNIT AND 10 SF FOR ADDITIONAL UNITS

 AS PER ZR 23-153 THE MAXIMUM FLOOR AREA RATIO PERMITTED IS 5.0, MAXIMUM LOT COVERAGE IS 70%.

- ALL PARAPETS ARE 3'-6" HIGH THUS AS PER ZR 12-10 DEFINITION OF FLOOR AREA AT ITEM (10); THE PARAPETS DO NOT CONSTITUTE AN ENCLOSURE NO MORE THAN 67% OF THE PERIMETER OF SUCH BALCONY OR TERRACE ENCLOSED.

- AS PER ZR 23-441 B(3) THE GREENHOUSE SHALL BE LIMITED TO AN AREA LESS THAN 25% OF THE REQUIRED REAR YARD. AS PER ZN 23-52 (B) REQUIRED REAR YARD MAY BE REDUCED BY SIX INCHES FOR EACH FOOT BY WHICH THE DEPTH OF THE ZONING LOT IS LESS THAN 90'. THE REQUIRED REAR YARD IS 22'-6" AND THE REQUIRED REAR YARD IS 1,125 SQFT. THE AREA OF GREENHOUSE SHALL BE 281.3 SQFT, THE EXISTING GREENHOUSES ARE 290SF & 230SF

FAR CALCULATION										
FLOOR		BUILDING CODE	FA DED	UCTION	ZONING NET FLOOR AREA (s					
	DESCRIPTION	FLOOR AREA (sf)	ID	SF	COMMERCIAL	RESIDENTIAL				
CEL	RETAIL	1849			0					
1ST	RETAIL	1083	M1	86.5	996.5					
2ND	RES. UNIT 2	1511.9	M2	1.25		1510.65				
3RD	RES. UNIT2	1511.9	М3	1.25		1510.65				
4TH	RES. UNIT 2	1511.9	M4	1.75		1510.15				
5TH	RES. UNIT 2	1511.9	M5	2.25		1509.65				
6TH	RES. UNIT 2	947	M6	2.50		944.50				
	TOTAL ZO	798	2 SF							

ZONING NOTES

Zoning Resolution Articles that apply to this project: **Article II: Residence District Regulations Chapter 3- Residential Bulk Regulations in Residence Districts**

ZR 23-60

Height And Setback Regulations

ZR 23-66: Height And Setback Requirements for Quality Housing Buildings ZR 23-662: Maximum Height of Buildings and Setback regulations (c) Setback requirements

For all Quality Housing buildings, a setback shall be provided in accordance with the following regulations:

(1) At a height not lower than the minimum base height or higher than the maximum base height specified for the applicable district in paragraph (b) of this Section, a setback with a depth of at least 10 feet shall be provided from any street wall fronting on a wide street, and a setback with a depth of at least 15 feet shall be provided from any street wall fronting on a narrow street.

(2) The depth of such required setback may be reduced by one foot for every foot that the street wall is located beyond the street line, but in no event shall a setback of less than seven feet in depth be provided, except as otherwise set forth in this Section. To allow street wall articulation, where a street wall is divided into different segments and located at varying depths from the street line, such permitted setback reduction may be applied to each street wall portion separately.

(3) Notwithstanding the provisions of paragraph (c)(2) above, the depth of such setbacks may include the depth of recesses or outer courts in the street wall of the building base, provided that the aggregate width of any such recessed portion of a street wall with a setback less than seven feet, as applicable, does not exceed 30 percent of the aggregate width of street wall at any level.

(4) These setback provisions are optional for any building wall that either is located beyond 50 feet of a street line, or oriented so that lines drawn perpendicular to it, in plan, would intersect a street line at an angle of 65 degrees or less. In the case of an irregular street line, the line connecting the most extreme points of intersection shall be deemed to be the street line. Furthermore, dormers provided in accordance with the provisions of Section 23-621 (Permitted obstructions in certain districts) may penetrate a required setback area.

PROJECT INFORMATION:

ADDRESS: 460-462 WEST BROADWAY NEW YORK, NY 10012

DATE: 06/23/2022

GROSS FLOOR AREA: 15,204SF

ARCHITECT OF RECORD:



DY-O DESIGN OFFICE 143 WEST 29 STREET NEW YORK, NY 10001 SUITE# 902A

CONTACT: STEFANO MORISI R.A. T: 1-917-960-3961 E: INFO@STUDIODYO.COM

DESIGN ARCHITECT:



VIA MARCONI, 43 CASALECCHIO DI RENO, (BO) ARCHITETTO@CARDINFONTANA.IT WWW.CARDINFONTANA.IT

OWNER:

CRISTINA CALORI CCNY REALTY, INC. 444 MADISON AVE NEW YOR, NY 10022

DOB JOB #: 120070485

DISCLAIMER:

The architect shall not have control or charge of and shall not be responsible for construction means methods, deviations, techniques, sequences or procedures, or for safety precautions and programs in connection with the work, for the acts or ommisions of the contractor, sub-contractors, or any other persons performing any of the work, or for the failure of any of them to carry out the work in accordance with the contract documents, written dimensions on this drawing shall have precedence over scaled dimensions. Contractors shall verify and be responsible for all dimensions and conditions on the job and this office must be notified of any variations from the dimensions and conditions shown by these drawings. shop details must be submitted to this office for review before proceeding with fabrication. not valid for construction unless signed and sealed by the architect and approved by the department of buildings.

 Rev
 Date
 Description

 1
 12/11/2023
 DOB Submission 1

SHEET TITLE:

GENERAL NOTES ZONING & LPC


SEAL AND SIGNATURE



DRAWN BY CHECKED BY

DYO NO.

MM/DD/YYYY

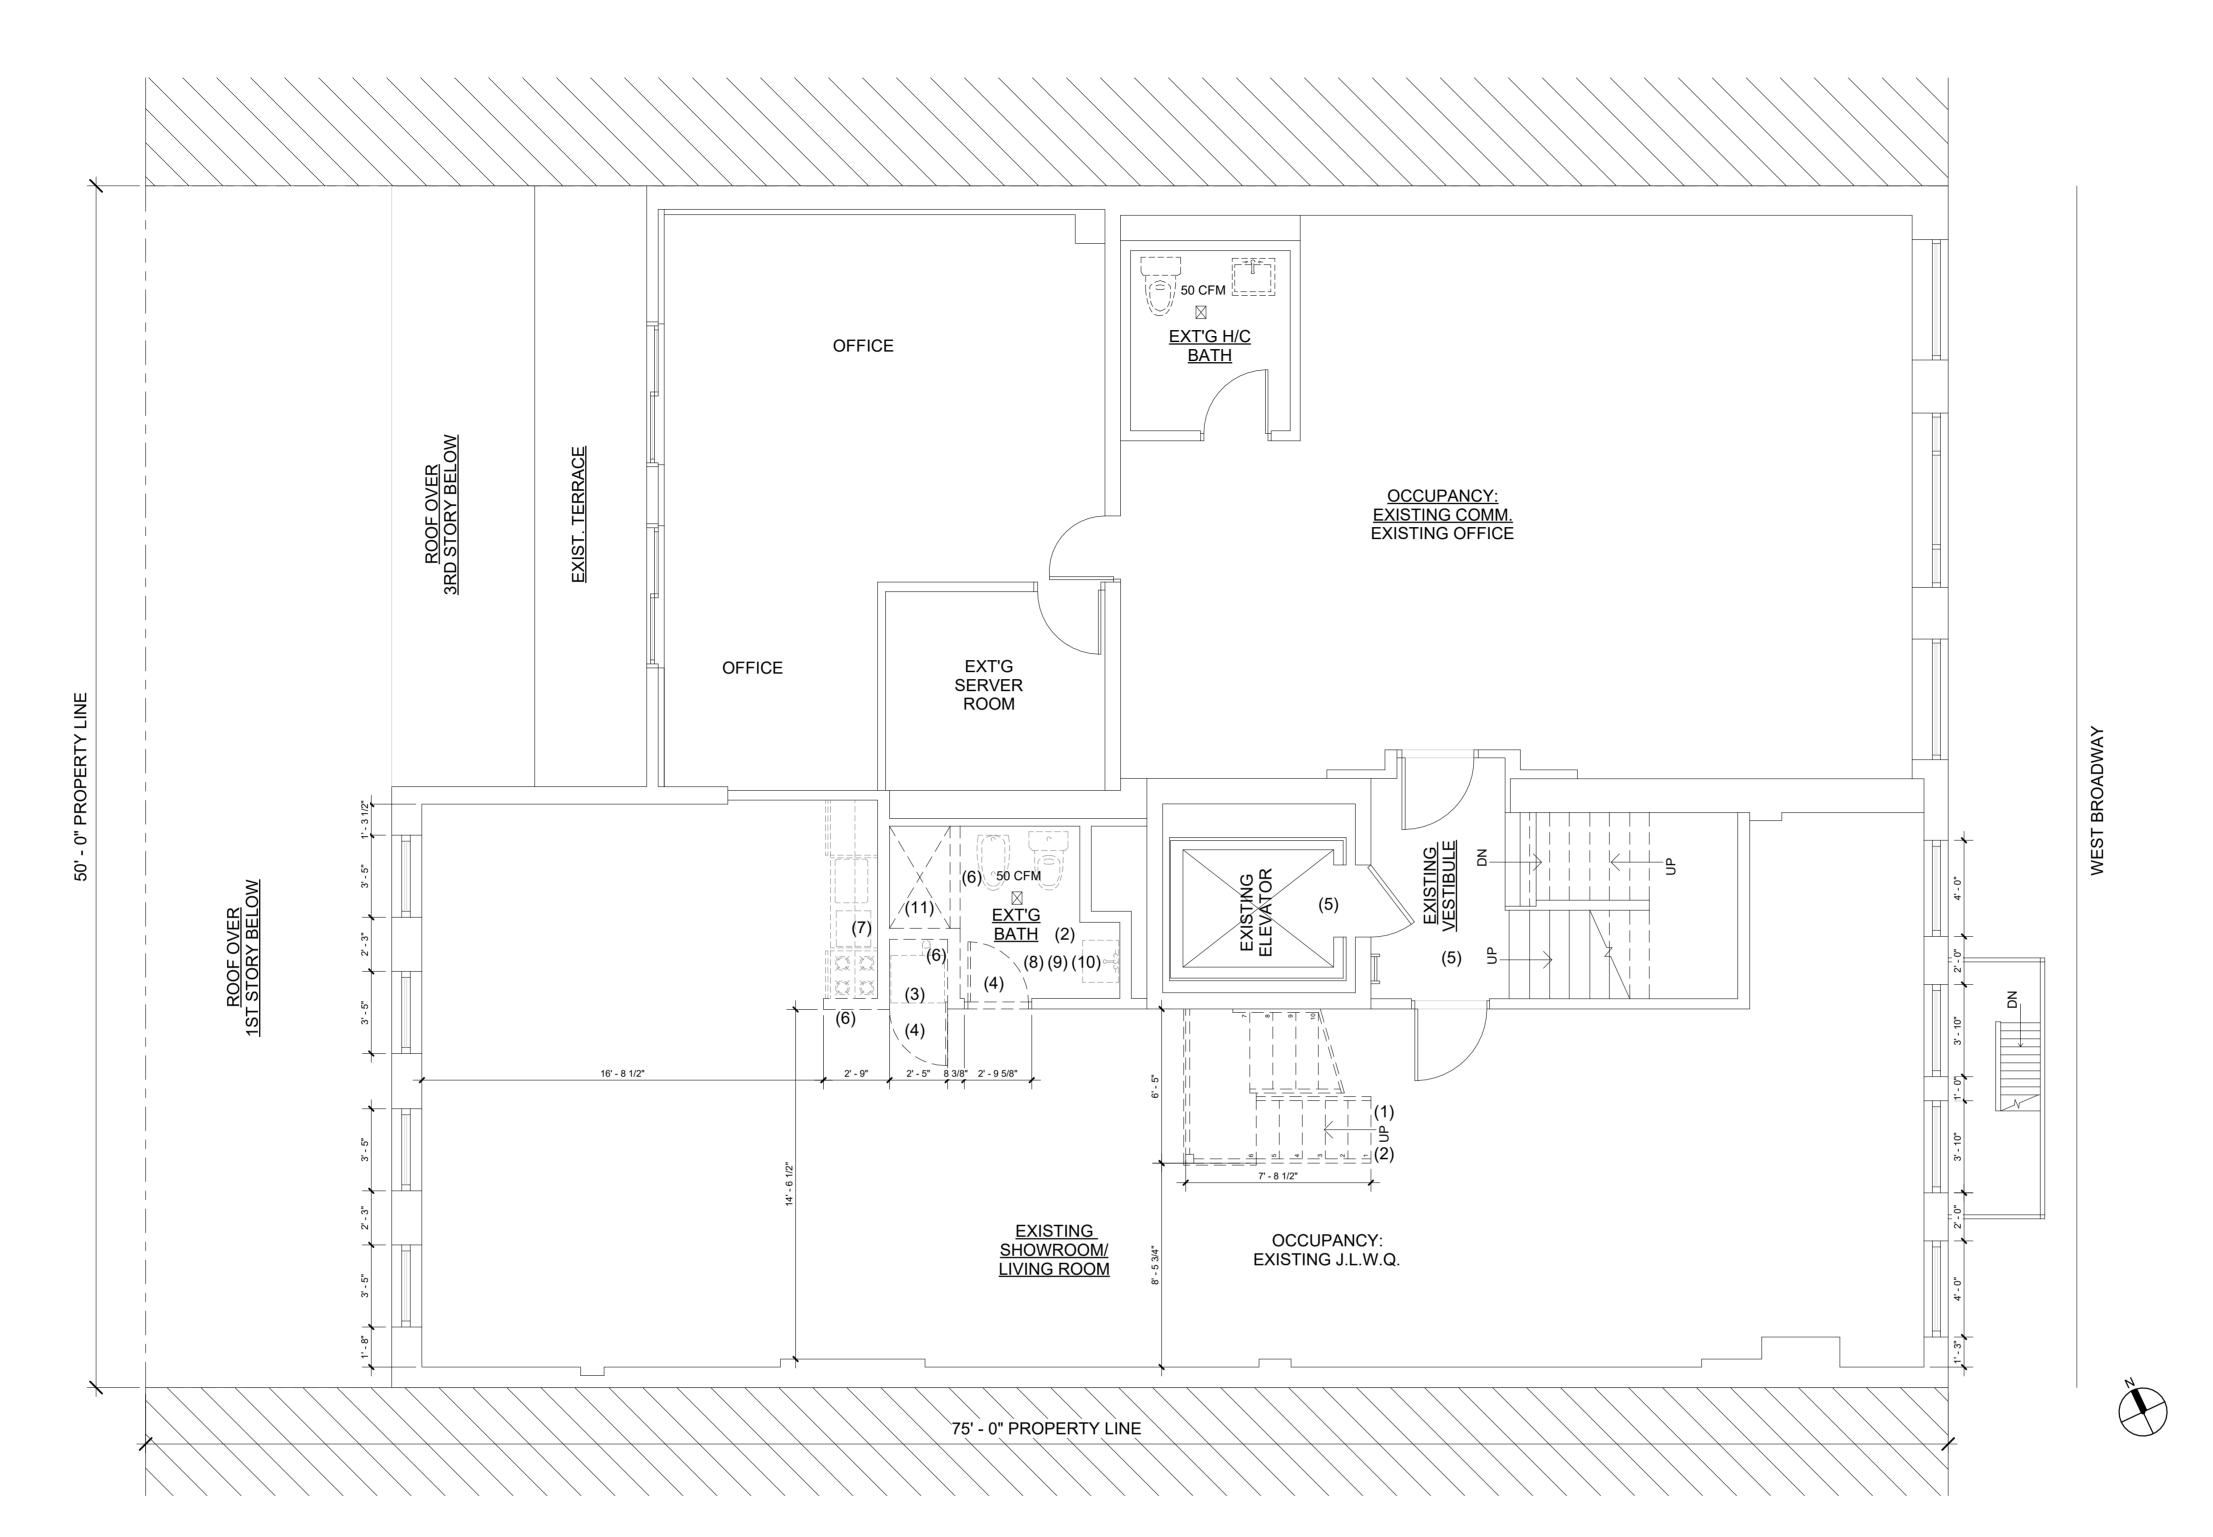

1 DEMO 5TH FLOOR 1/4" = 1'-0"

LEGEND DEMOLITION NOTES GENERAL DEMOLITION NOTES: 1. REMOVE EXISTING WOOD STAIRCASE. REMOVE STAIRCASE 1. REMOVE EXISTING WOOD STAIRCASE AND PATCH AWAY REMAINING WOOD THAT WILL BE EXPOSED. [__] DEMOLITION PARTITION. EXISTING PARTITION TO REMAIN 2. REMOVE EXISTING PARTITIONS INCLUDING GYPSUM BOARD, WOOD, AND METAL FRAMES. 2. ALL TILES AND FIXTURES TO BE REMOVED. NEW PARTITION 3. REMOVE EXISTING BATHROOM FIXTURES. (GC TO PROTECT APARTMENTS BELOW. 3. EXISTING WASHER DRYER TO BE RELOCATED ON SIXTH FLOOR. 4. DEMOLITION AND CONSTRUCTION DEBRIS SHALL BE REMOVED DAILY 4. DOORS TO BE REMOVED. 5. EXISTING BUILDING MAIN STAIRS AND ELEVATOR TO REMAIN. 6. PARTITION WALLS TO BE REMOVED. 7. KITCHEN EQUIPMENT TO BE REMOVED. 8. EXITING BATHROOM TO BE DEMO'D. 9. ALL PLUMBING FIXTURES TO BE REMOVED. 10. CEILING FIXTURES TO BE REMOVED. 11. EXISTING SHOWER TO BE REMOVED AND RELOCATED.

PROJECT INFORMATION:

ADDRESS: 460-462 WEST BROADWAY NEW YORK, NY 10012

DATE: 06/23/2022

GROSS FLOOR AREA: 15,204SF

ARCHITECT OF RECORD:

design office

DY-O DESIGN OFFICE 143 WEST 29 STREET NEW YORK, NY 10001 SUITE# 902A

CONTACT: STEFANO MORISI R.A. T: 1-917-960-3961 E: INFO@STUDIODYO.COM

DESIGN ARCHITECT:

Architect Monica Cardin Fontana architetto@cardinfontana.it - www.cardinfontano.it

VIA MARCONI, 43 CASALECCHIO DI RENO, (BO) ARCHITETTO@CARDINFONTANA.IT WWW.CARDINFONTANA.IT

OWNER:

CRISTINA CALORI CCNY REALTY, INC. 444 MADISON AVE NEW YOR, NY 10022

DOB JOB #: 120070485

DISCLAIMER:

The architect shall not have control or charge of and shall not be responsible for construction means, methods, deviations, techniques, sequences or procedures, or for safety precautions and programs in connection with the work, for the acts or ommisions of the contractor, sub-contractors, or any other persons performing any of the work, or for the failure of any of them to carry out the work in accordance with the contract documents. written dimensions on this drawing shall have precedence over scaled dimensions. Contractors shall verify and be responsible for all dimensions and conditions on the job and this office must be notified of any variations from the dimensions and conditions shown by these drawings. shop details must be submitted to this office for review before proceeding with fabrication. not valid for construction unless signed and sealed by the architect and


 Rev
 Date
 Description
 Issued By
 Issued To


 1
 12/11/2023
 DOB Submission 1
 DYO
 DOB

approved by the department of buildings.


SHEET TITLE:

FIFTH FLOOR DEMO PLAN

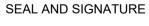

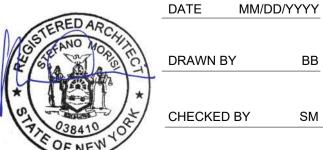

CHECKED BY DYO NO. 220809

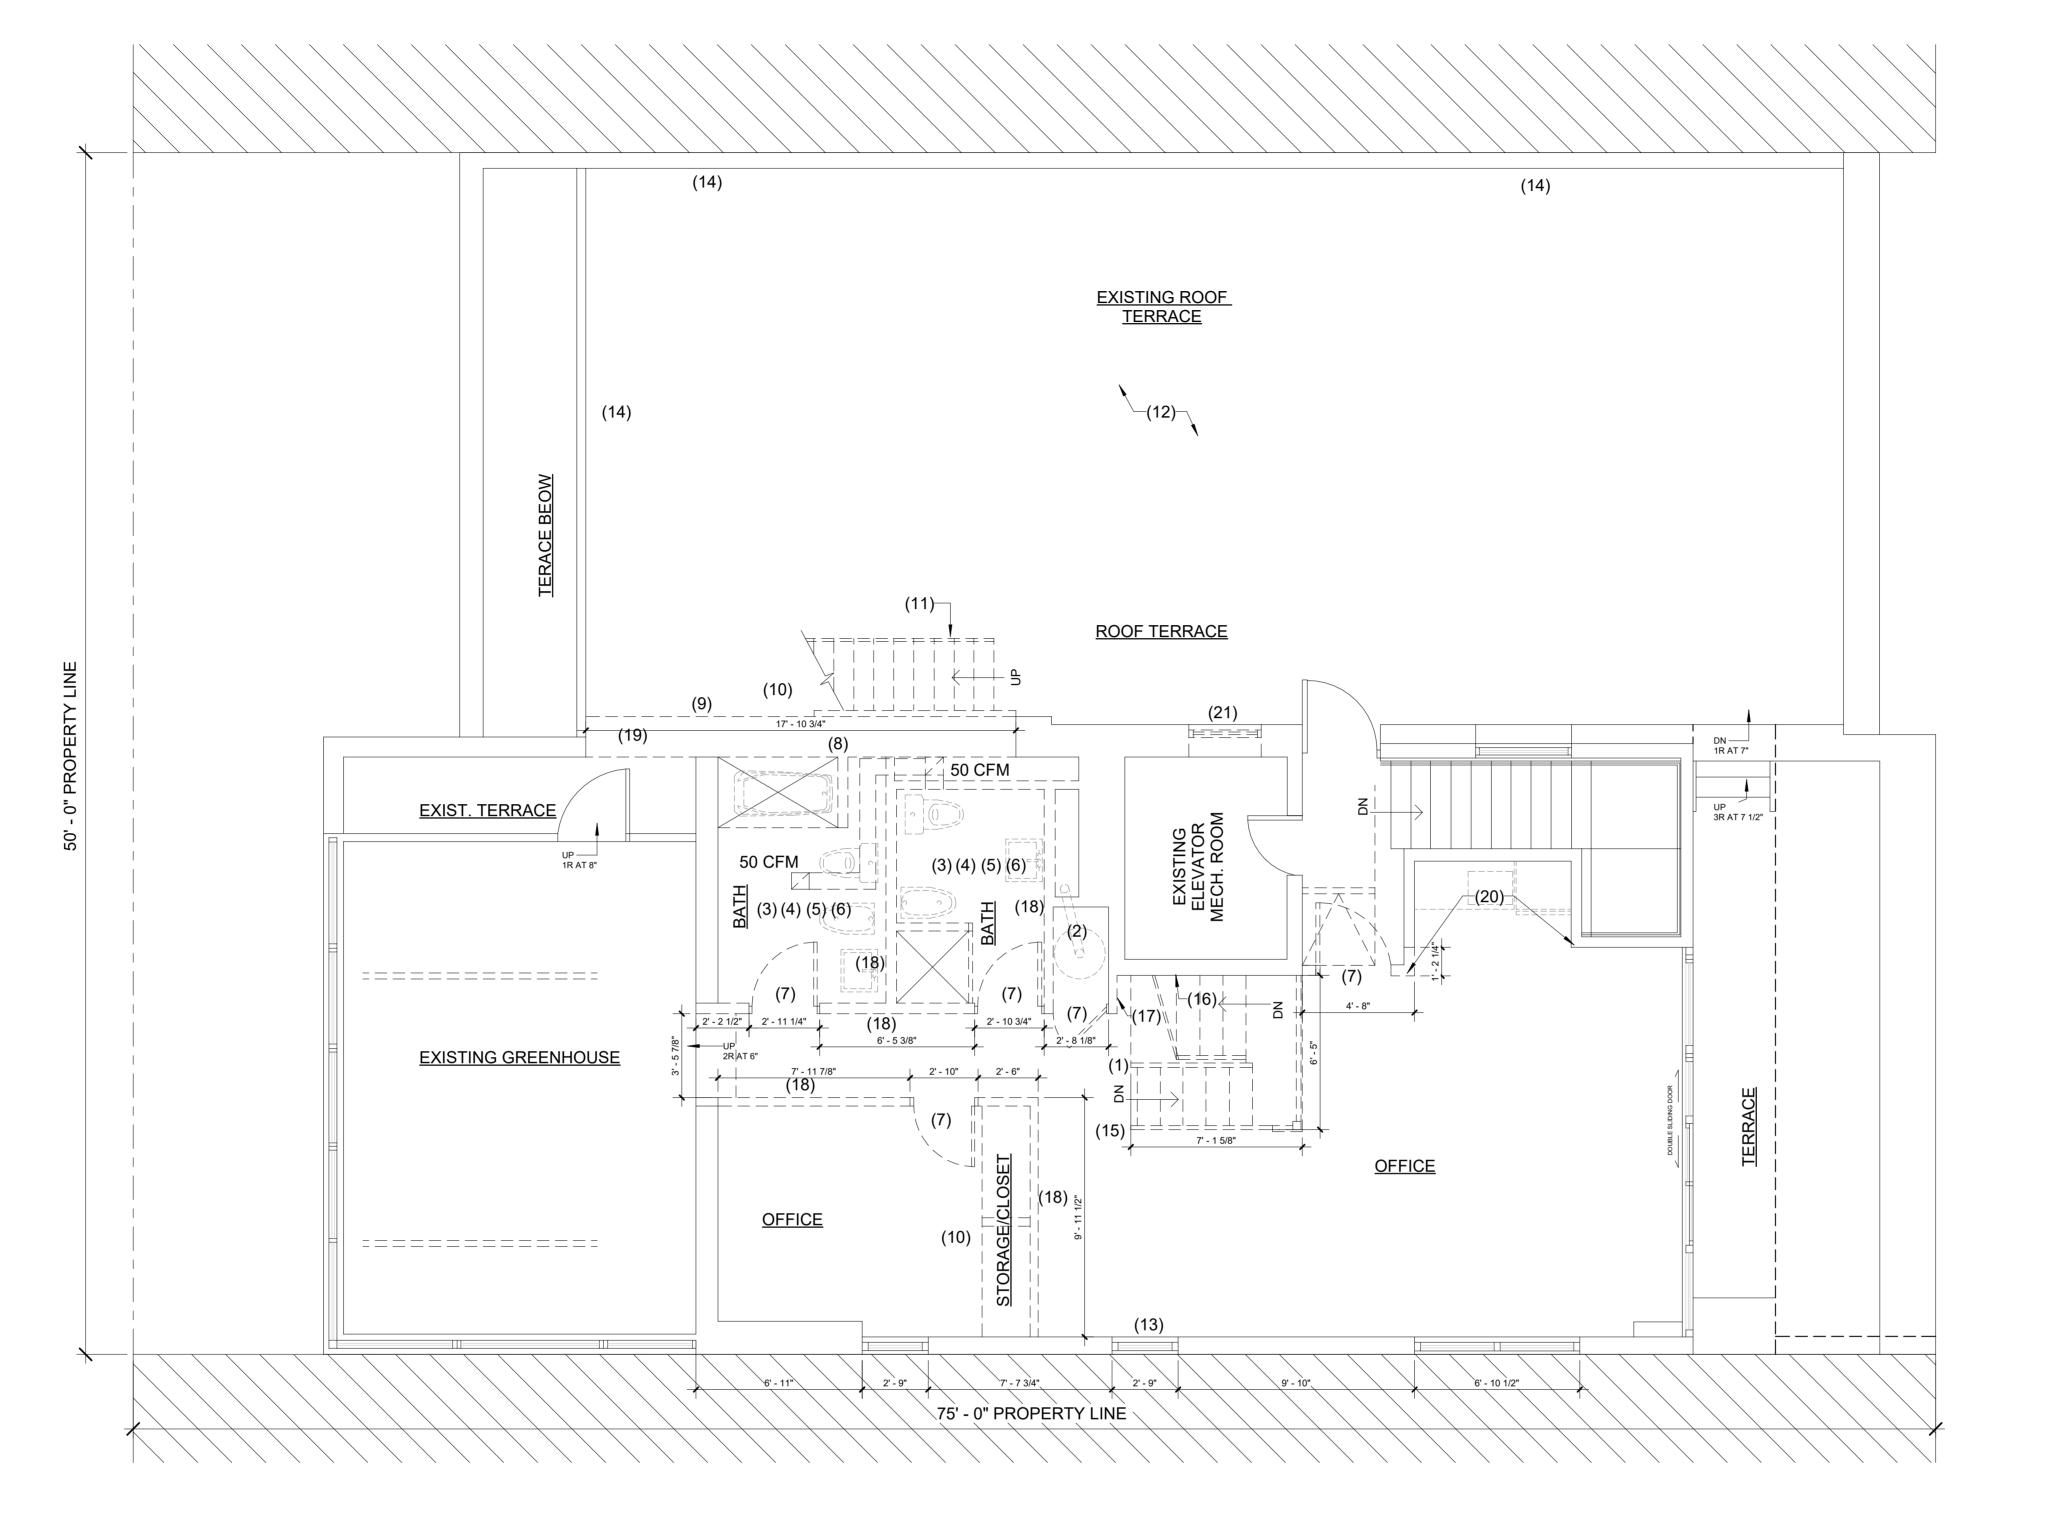

GENERAL DEMOLITION NOTES:

1 DEMO 6TH FLOOR 1/4" = 1'-0"

DEMOLITION NOTES

20. ALIGN WALL WITH EXISTING PARTITION.

LEGEND

		1. REMOVE EXISTING INTERIOR STAIRCASE.	1. REMOVE EXISTING WOOD STAIRCASE AND PATCH AWAY REMAINING WOOD THAT WILL BE EXPOSED.
	DEMOLITION	2. EXISTING WATER HEATER TANK TO BE REMOVED. PLUMBING TO BE CAPPED.	2. REMOVE EXISTING PARTITIOS INCLUDING GYPSUM BOARD, WOOD, AND METAL FRAMES.
	EXISTING PARTITION TO REMAIN NEW PARTITION	3. EXISTING BATHROOM TO BE DEMO'D.	3. REMOVE EXISTING BATHROOM FIXTURES. (GC TO PROTECT APARTMENTS BELOW)
		4. ALL PLUMBING FIXTURES TO BE REMOVED.	4. DEMOITION AND CONSTRUCTION DEBRIS SHALL BE REMOVED DAILY.
		5. ALL EXISTING PLUMBING TO BE CAPPED.	5. G.C SHALL MAINTAIN ELEVATORS, HALLWAYS, STAIRCASE AND OTHER COMMON SOACES FREE OF
		6. CEILING FIXTURES TO BE REMOVED.	MATERIALS, TOOLS AND GARBAGE.
		7. DOORS TO BE REMOVED.	6. EXISTING SPACES WHERE NO WORK IS DONE SHALL REMAIN FREE OF DUST AND DEBRIS.
		8. NEW OPENING ON EXISTING WALL DOWN TO INTERIOR FLOOR LEVEL (L 10'-7" x H10'-0")	
		9. EXISTING EXTERIOR HOWER TO BE REMOVED. PLUMBING TO REMAIN FOR NEW USE	
		10. EXISTING CLOSET TO BE REMOVED.	
		11. EXISTING METAL STAIRCASE TO BE REMOVED.	
		12. EXISTING WOOD COMPOSITRE FLOOR TO BE REMOVED FROM TERRACE.	
		13. EXISTING WINDOW TO BE REMOVED. PREP OPENING FOR NEW LARGER SIZE WINDOW. SEE PROPOSED.	
		14. FENCE AROUND TERRACE PERIMETER TO BE REMOVED AND REPLACED.	
		15. DEMO FLOOR TO MEET NEW STAIR POINT OF ARRIVAL. SEE PROPOSED DRAWINGS.	
		16. ALIGN TOP WALL WITH WALL BENEATH. WALL TO BE FLUSH ACCORDING TO 5TH FLOOR FACE.	
		17. DEMO WALL TO BE FLUSH WITH WALL ADJACENT TO STAIR. ELECTRICAL EQUIPMENT TO BE RELOCATD.VIF.	
Σ		18. PARTITION WALLS TO BE REMOVED.	
38:06		19. EXT. WALL TO BE PARTLY DEMO'D. ALLOW ENTRY TO TERRACE FROM GREENHOUSE ROOM.	
-:			

21. EXTERIOR WINDOW FROM ELEVATOR MECHANICAL ROOM TO BE REMOVED.

LOT LINE WINDOW CALCULATIONS

MASONRY WALL AREA = 41.5' x 11' = 456.5 SF PERMITTED OPENINGS AS PER TABLE 3-4 = 10% x 456.5 = 45.65 S.F. PROPOSED WALL OPENINGS = 12 + 12 + 21 = 45 S.F.

PROJECT INFORMATION:

ADDRESS: 460-462 WEST BROADWAY NEW YORK, NY 10012

DATE: 06/23/2022

GROSS FLOOR AREA: 15,204SF

ARCHITECT OF RECORD:

design office

DY-O DESIGN OFFICE 143 WEST 29 STREET NEW YORK, NY 10001 SUITE# 902A

CONTACT: STEFANO MORISI R.A. T: 1-917-960-3961 E: INFO@STUDIODYO.COM

DESIGN ARCHITECT:

Architect Monica Cardin Fontana architetto@cardinfontana.it - www.cardinfontana.it

VIA MARCONI, 43 CASALECCHIO DI RENO, (BO) ARCHITETTO@CARDINFONTANA.IT WWW.CARDINFONTANA.IT

OWNER:

CRISTINA CALORI CCNY REALTY, INC. 444 MADISON AVE NEW YOR, NY 10022

DOB JOB #: 120070485

DISCLAIMER:

The architect shall not have control or charge of and shall not be responsible for construction means, methods, deviations, techniques, sequences or procedures, or for safety precautions and programs in connection with the work, for the acts or ommisions of the contractor, sub-contractors, or any other persons performing any of the work, or for the failure of any of them to carry out the work in accordance with the contract documents. written dimensions on this drawing shall have precedence over scaled dimensions. Contractors shall verify and be responsible for all dimensions and conditions on the job and this office must be notified of any variations from the dimensions and conditions shown by these drawings. shop details must be submitted to this office for review before proceeding with fabrication. not valid for construction unless signed and sealed by the architect and

 Rev
 Date
 Description
 Issued By
 Issued To


 1
 12/11/2023
 DOB Submission 1
 DYO
 DOB

approved by the department of buildings.


SHEET TITLE:

SIXTH FLOOR DEMO PLAN



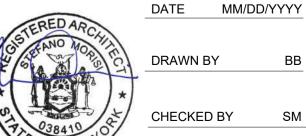

DRAWN BY CHECKED BY

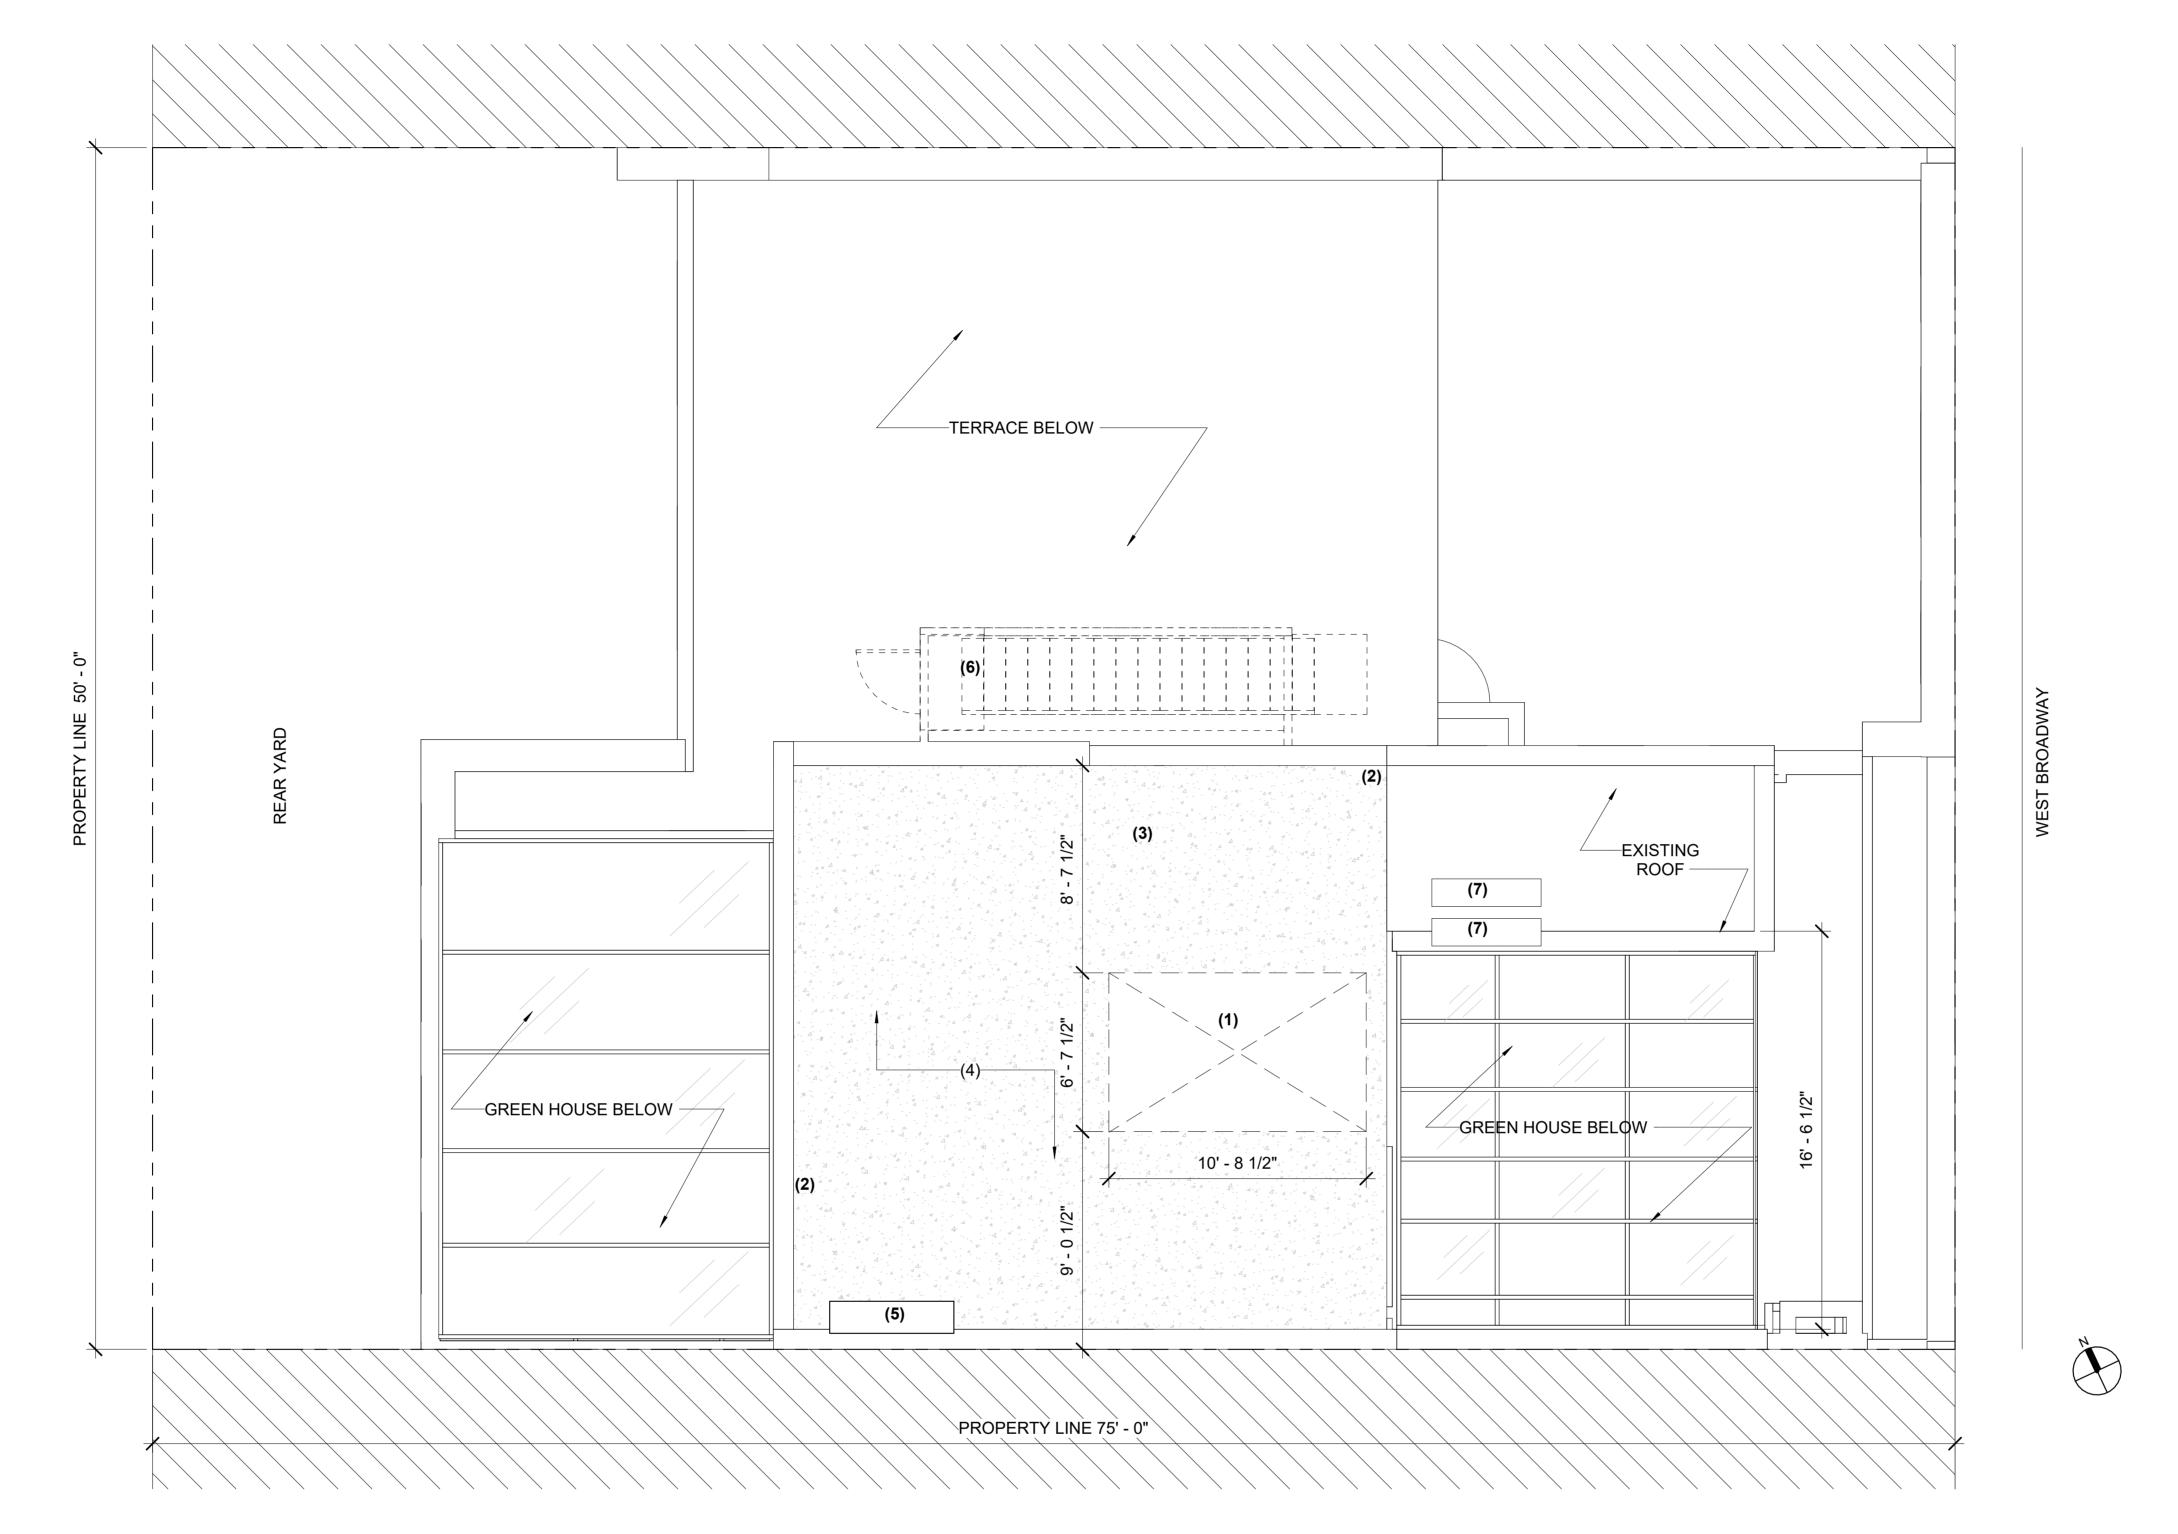

1 ROOF DEMO PLAN 1/4" = 1'-0"

7. EXISTING HVAC SPLIT SYSTEM TO REMAIN.

LEGEND GENERAL DEMOLITION NOTES: DEMOLITION NOTES 1. WHEN REMOVING EXTERIOR ELEMENTS G.C. SHALL CONFIRM ROOF MEMBRANES REMAIN FREE OF [__] DEMOLITION 1. NEW ROOF OPENING 7'-2" x 10'-8 1/2". PENETRATIONS. EXISTING PARTITION TO REMAIN 2. EXISTING HAND RAILINGS TO BE REMOVED DOWN TO PARAPET 2. NO MATERIAL THAT CAN BE LIFTED BY THE WIND SHALL BE LEFT IN ROOF TOP. NEW PARTITION 3. EXISTING METAL DUCT WORK TO BE RELOCATED. 4. EXISTING WOOD COMPOSITE FLOOR TO REMAIN. 5. EXISTING BRICK SHAFT TO REMAIN. 6. EXISTING METAL STAIRCASE TO BE REMOVED.

PROJECT INFORMATION:

ADDRESS: 460-462 WEST BROADWAY NEW YORK, NY 10012

DATE: 06/23/2022

GROSS FLOOR AREA: 15,204SF

ARCHITECT OF RECORD:

DY-O DESIGN OFFICE 143 WEST 29 STREET NEW YORK, NY 10001 SUITE# 902A

CONTACT: STEFANO MORISI R.A. T: 1-917-960-3961 E: INFO@STUDIODYO.COM

DESIGN ARCHITECT:

Architect Monica Cardin Fontana architetto@cardinfontana.it - www.cardinfontano.it

VIA MARCONI, 43 CASALECCHIO DI RENO, (BO) ARCHITETTO@CARDINFONTANA.IT WWW.CARDINFONTANA.IT

CRISTINA CALORI CCNY REALTY, INC. 444 MADISON AVE **NEW YOR, NY 10022**

DOB JOB #: 120070485

DISCLAIMER:

The architect shall not have control or charge of and shall not be responsible for construction means, methods, deviations, techniques, sequences or procedures, or for safety precautions and programs in connection with the work, for the acts or ommisions of the contractor, sub-contractors, or any other persons performing any of the work, or for the failure of any of them to carry out the work in accordance with the contract documents. written dimensions on this drawing shall have precedence over scaled dimensions. Contractors shall verify and be responsible for all dimensions and conditions on the job and this office must be notified of any variations from the dimensions and conditions shown by these drawings. shop details must be submitted to this office for review before proceeding with fabrication. not valid for construction unless signed and sealed by the architect and

 Rev
 Date
 Description
 Issued By
 Issued To

 1
 12/11/2023
 DOB Submission 1
 DYO
 DOB

approved by the department of buildings.

SHEET TITLE:

ROOF DEMO PLAN


SEAL AND SIGNATURE



DRAWN BY

CHECKED BY SM

DATE MM/DD/YYYY

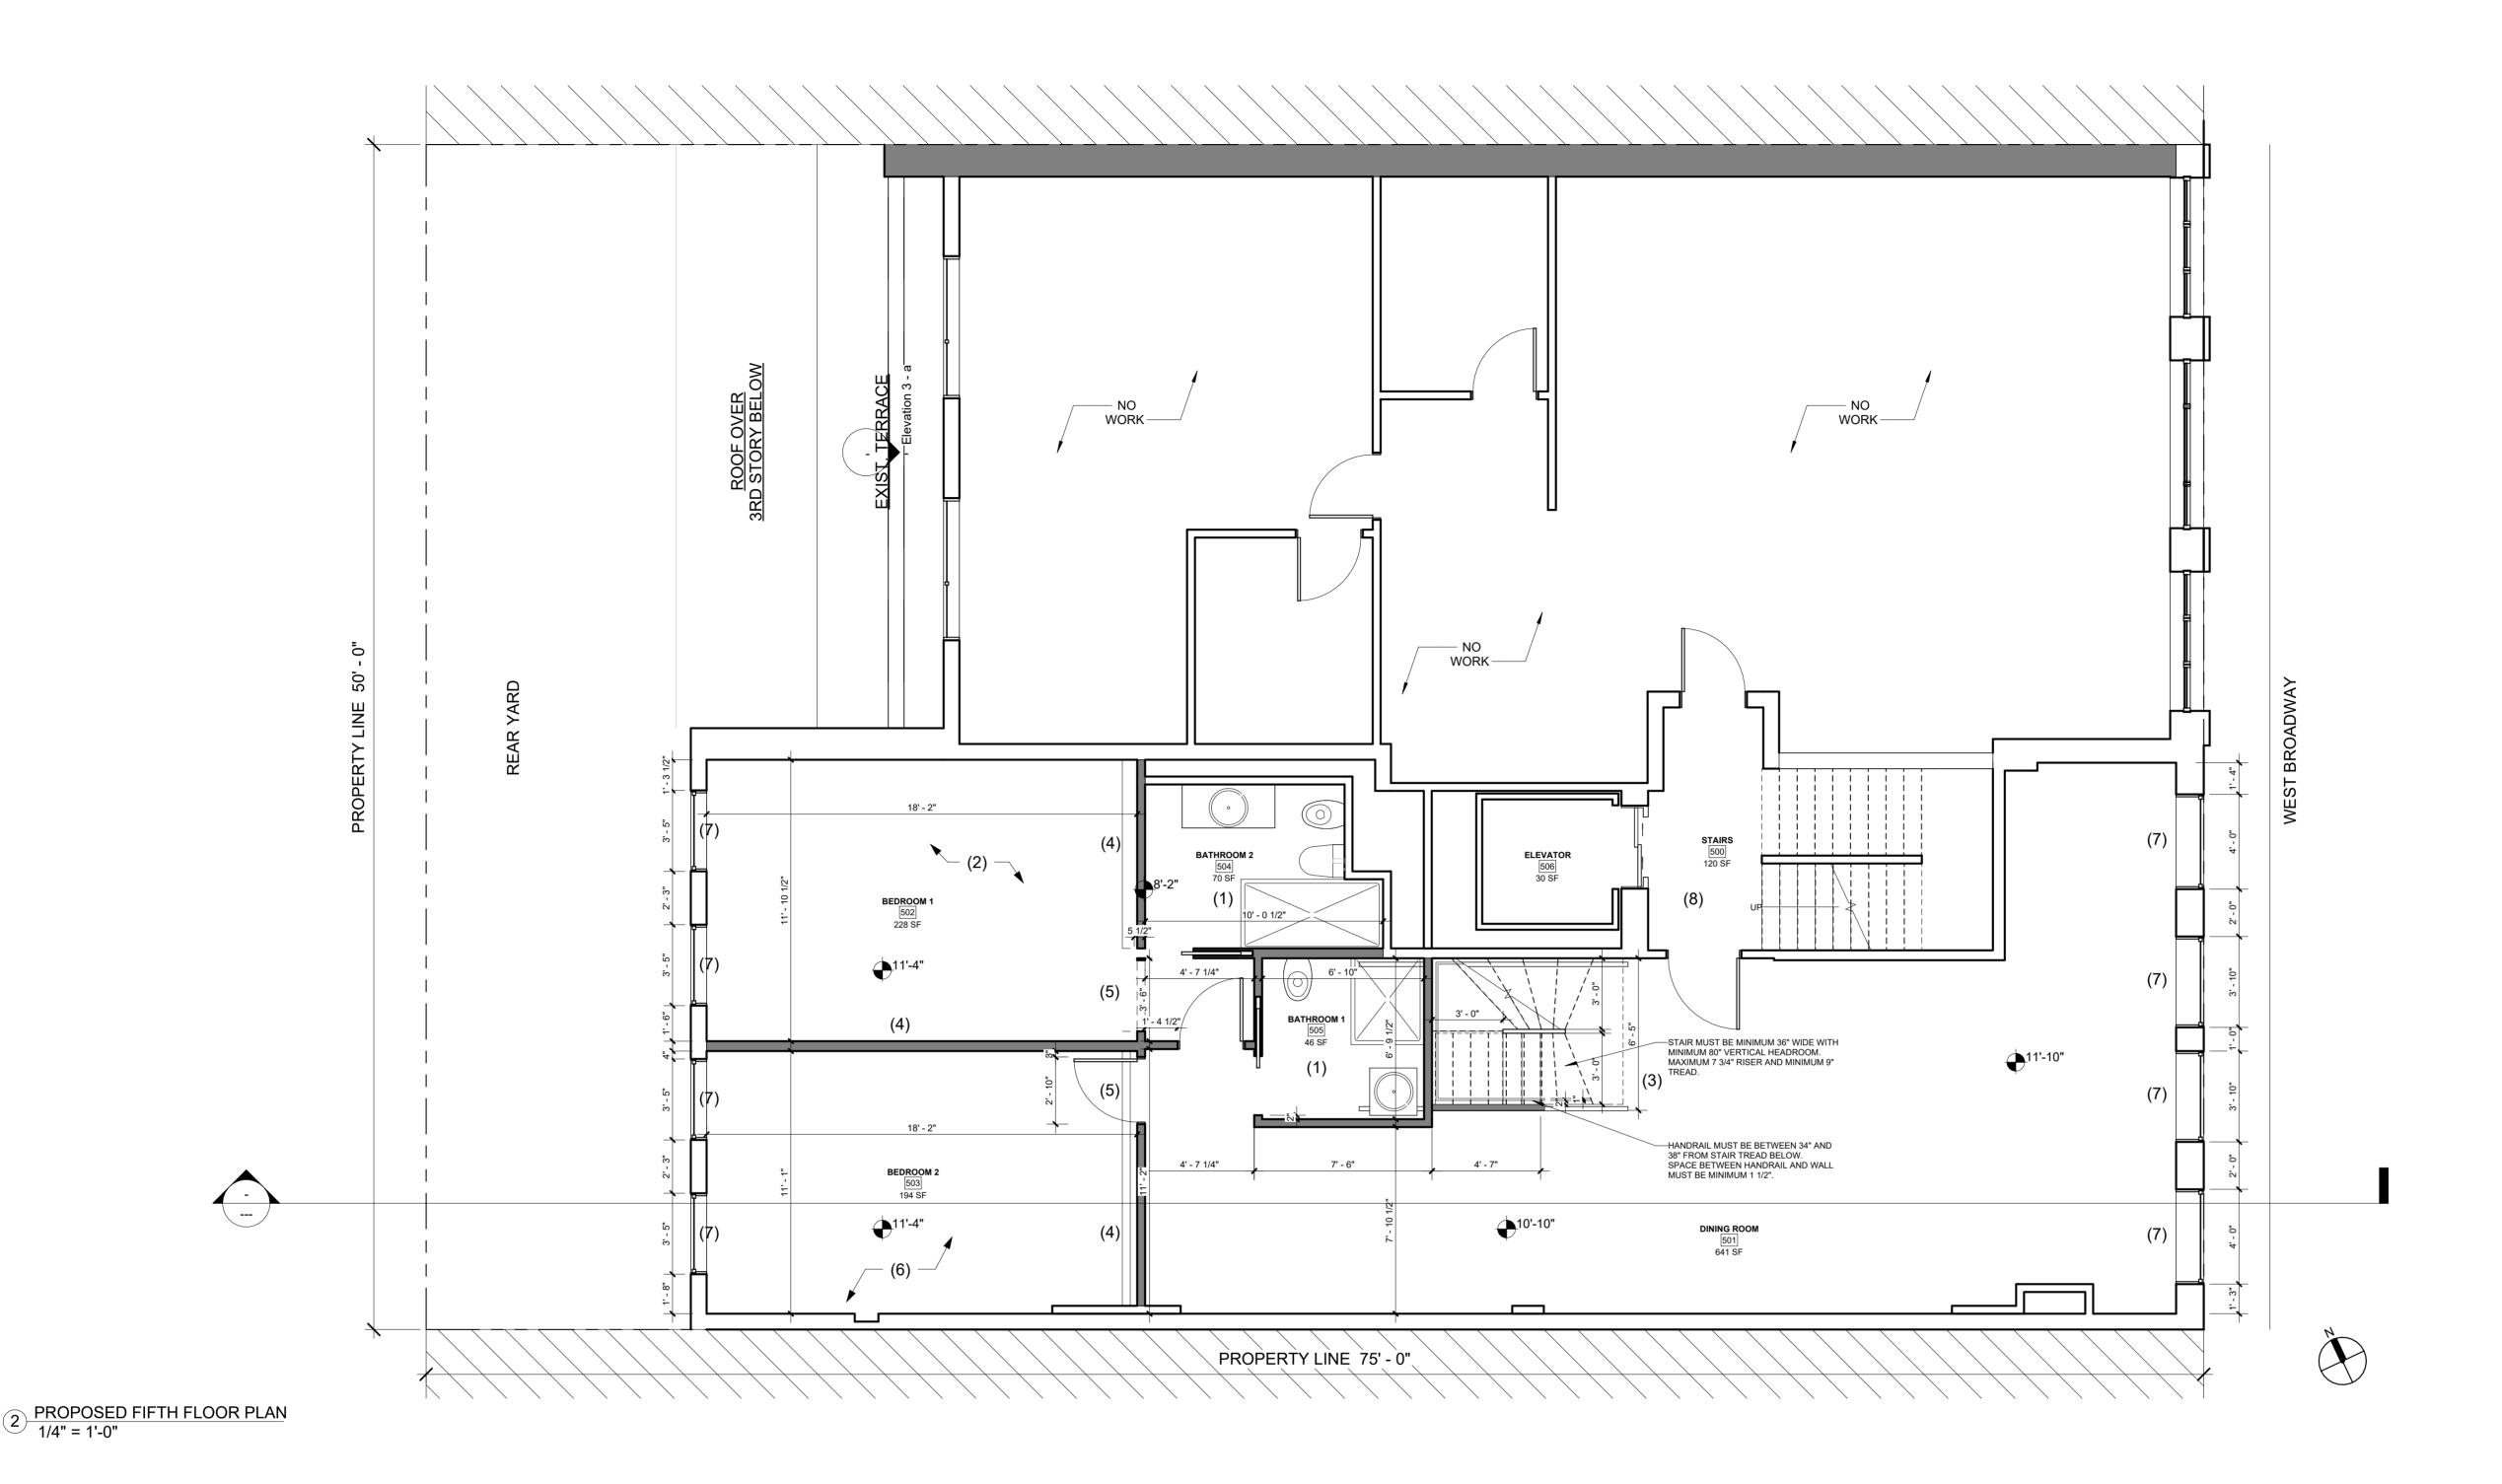

ADDRESS: 460-462 WEST BROADWAY NEW YORK, NY 10012

DATE: 06/23/2022 GROSS FLOOR AREA: 15,204SF

PROJECT INFORMATION:

ARCHITECT OF RECORD:

DY-O DESIGN OFFICE 143 WEST 29 STREET NEW YORK, NY 10001 SUITE# 902A

CONTACT: STEFANO MORISI R.A. T: 1-917-960-3961 E: INFO@STUDIODYO.COM

DESIGN ARCHITECT:

Architect Monica Cardin Fontana architetto@cardinfontana.it - www.cardinfontana.

VIA MARCONI, 43 CASALECCHIO DI RENO, (BO) ARCHITETTO@CARDINFONTANA.IT WWW.CARDINFONTANA.IT

CRISTINA CALORI CCNY REALTY, INC. 444 MADISON AVE **NEW YOR, NY 10022**

DOB JOB #: 120070485

DISCLAIMER:

The architect shall not have control or charge of and shall not be responsible for construction means, methods, deviations, techniques, sequences or procedures, or for safety precautions and programs in connection with the work, for the acts or ommisions of the contractor, sub-contractors, or any other persons performing any of the work, or for the failure of any of them to carry out the work in accordance with the contract documents. written dimensions on this drawing shall have precedence over scaled dimensions. Contractors shall verify and be responsible for all dimensions and conditions on the job and this office must be notified of any variations from the dimensions and conditions shown by these drawings. shop details must be submitted to this office for review before proceeding with fabrication. not valid for construction unless signed and sealed by the architect and approved by the department of buildings.

 Rev
 Date
 Description

 1
 12/11/2023
 DOB Submission 1

FIRE DEPARTMENT NOTES

REAR OF THE BUILING AND FROM ONE SIDE OF THE

ACCESS LANDING REQUIERED PERSUANT TO FC504.4.3

IT SHALL AFFORD ACCESS TO THE BULKHEAD DOOR

AND ANY ACCESS LADDERS, SKYLIGHTS, SCUTTLES

AND SHAFTS. A CONDUIT OR PIPE MAY CROSS SUCH

PATH IN ACCORDANCE WITH FC504.4.7 A FIXED LADDER

OR OTHER APPROVED MEANS SHALL BE PROVIDED TO

AFFORD ACCESS ALONG THE CLEAR PATH RFROM ONE

ROOF LEVEL TO THE NEXT, INCLUDING THE BULKHEAD.

2. AS PER 504.4.3AN ACCESS LANDING 6' IN ANY

REQUIERD.

DIMENSINON CONNECTED TO THE CLEAR PATH IS

BUILDING TO THE OTHER . SUCH PATH SHALL BE

ACCESSIBLE FROM EACH ROOFTOP PERIMETER

1. AS PER FDNY 504.4.4 A CLEAR PATH OF NOT LESS THAN 6' HORIZONTAL WIDTH OF 9' IN HEIGHT SHALL BE PROVIDED FROM THE FRONT OF THE BUILDING TO THE

SHEET TITLE: PROPOSED FIFTH



DRAWN BY CHECKED BY

DYO NO.

MM/DD/YYYY

PROPOSED WORK KEY NOTES:

DEMOLITION EXISTING PARTITION TO REMAIN

LEGEND

NEW PARTITION

1. NEW W/C AND HAND SINK

2. NEW KITCHEN 3. NEW STAIRS TO 6TH FLOOR. WITH RAILING AND 3.GC TO ISOLATE FLOOR AND CEILING WITH PLASTIC SHEATHING.

GLASS PANEL. SEE STAIR DETAIL. 4. NEW PARTITION WALLS.

5. NEW OPENINGS AND DOORS.

NEW BEDROOM.

7. FACADE/EXTERIOR WINDOWS TO REMAIN THE

8. EXISTING BUILDING MAIN STAIRCASE AND ELEVATOR TO REMAIN.

GENERAL CONSTRUCTION NOTES:

1. GC TO PREVENT ANY DAMAGE TO FLOORS BELOW.

2. GC TO PROTECT ALL EXISTING FLOORS AND WALLS.

ALL INTERIOR STAIRS COMPLY WITH THE FOLLOWING CODE:

STAIR NOTES:

NYCBC 2022 1011 STAIRWAYS

1011.2 WIDTH AND CAPACITY THE MINIMUM WIDTH SHALL BE NOT LESS THN 44 INCHES

EXC 1.1. A WIDTH OF NOT LESS THAN 36 INCHES SHALL BE PERMITTED IN A STAIRWAY THAT SERVES AN OCCUPANT LOAD OF 50 OR LESS CUMULATIVE FOR ALL STORIES.

1011.3 HEADROOM STAIRWASY SHALL HAVE A HEADROOM CLEARANCE OF NOT LESS THAN 84 INCHES MEASURED VERTICALLY FROM A LINE CONNECTING THE EDGE OF NOSINGS. THE MINIMUM CLEARANCE SHALL

BE MAINTAINED THE FULL WIDTH OF THE STAIRWAY AND LANDING. EXC 1. IN GROUP R-2 AND R-3 CCUPANCIES STAIRWAYS SHALL HAVE A HEADROOM CLEARANCE OF NOT LESS THAN 80 INCHES.

1011.4 WALKLINE THE WALKLINE ACROSS WINDER TREADS SHALL BE CONCENTRIC TO THE DIRECTION OF TRAVEL THROUGH THE TURN AND LOCATED 12 INCHES FROM THE SIDE WHERE WINDERS ARE NARROWER. THE 12 INCH DIMENSION SHALL BE MEASURED FROM THE WIDEST POINT OF THE CLEAR STAIR WIDTH AT THE WALKING SURFACE OF THE WINDER, WHERE WINDERS ARE ADJACENT WITHIN THE FLIGHT, THE POINT OF THE WIDEST CLEAR STAIR WIDTH OF THE ADJACENT WINDERS SHALL

BE USED. 1011.5.2 RISER HEIGHT AND TREAD DEPTH

A RIGHT ANGLE TO THE TREAD'S NOSING.

STAIR RISER HEIGHTS SHALL BE 7 INCHES MAXIMUM AND 4 INCHES MINIMUM. THE RISER HEIGHT SHALL BE MEASURED VERTICALLY BETWEEN THE NOSINGS OF ADJACENT TREADS. RENCTANGULAR TREAD DEPTHS SHALL BE 11 INCHES MINIMUM MEASURED HORIZONTALLY BETWEEN THE VERTICAL PLANES OF THE FOREMOST PROJECTION OF ADJACENT TREADS AND AT

EXC. 3.1. IN GROUP R-2 OCCUPANCIES THE SUM OF TWO RISERS PLUS ONE TREAD EXCLUSIVE OF NOSING SHALL BE NOT LESS THAN 24 INCHES NOR MORE THAN 25 1/2 INCHES.

EXC.3.2. IN GROUP R-2 OCCUPANCIES THE MAXIMUM RISER HEIGHT SHALL BE 7 3/4 INCHES AND THE MINIMUM TREAD DEPTH SHALL BE 9 1/2 INCHES PLUS NOSING. TREADS MAY BE UNDERCUT A DISTANCE EQUAL TO THE NOSING. A NOSING NOT LESS THAN 3/4 INCH BUT NO MORE THAN 1 1/4 INCHES SHALL BE PROVIDED ON STAIRWAYS WITH SOLID RISERS WHERE THE TREAD DEPTH IS

LESS THAN 11 INCHES. EXC.5. WITHIN GROUP R-2 OCCUPANCIES WINDERS SHALL HAVE A MINIMUM TREAD DEPTH OF 10 INCHES MEASURED HORIZONTALLY BETWEEN THE VERTICAL PLANES OF THE FOREMOST PROJECTION OF ADJACENT TREADS AND AT A RIGHT ANGLE TO THE TREAD'S LEADING EDGE, WHEN MEASURED AT A POINT 12 INCHES FROM THE SIDE WHERE THE TREADS ARE NARROWER. WINDER TREADS HAVE TO HAVE A MINIMUM TREAD DEPTH OF 6 INCHES AT ANY POINT. WITHIN ANY FLIGHT OF STAIRS, THE GREATEST WINDER TREAD DEPTH AT THE 12 INCH WALK LINE SHALL NOT EXCEED THE SMALLEST BY MOE THAN 3/8 INCH.

1011.5.4 DIMENSIONAL UNIFORMITY

STAIR TREADS AND RISERS SHALL BE OF UNIFORM SIZE AND SHAPE. THE TOLERANCE BETWEEN THE LARGEST AND SMALLEST RISER HEIGHT OR BETWEEN THE LARGEST AND SMALLEST TREAD DEPTH SHALL NOT EXCEED 3/8 INCH IN ANY FLIGHT OF STAIRS. THE GREATEST WNDER TREAD DEPTH AT THE WALKLINE

EXC.2. CONSISTENTLY SHAPED WNDERS, COMPLYING WITH SECTION 1011.5, DIFFERING FROM RECTANGULAR

TREADS IN THE SAME FLIGHT OF STAIRS.

INCH FROM THE FOREMOST PROJECTION OF THE TREAD. RISERS SHALL BE SOLID AND VERTICAL OR SLOPED UNDER THE TREAD ABOVE FROM THE UNDERSIDE OF THE NOSING ABOVE AT AN ANGLE NOT MORE THAN 30 DEGREES FROM THE VERTICAL.

1011.5.5.1 NOSING PROJECTION SIZE THE LEADING EDGE (NOSINGS) OF TREADS SHALL PROJECT NOT MORE THAN 1 1/4 INCHES BEYOND THE TREAD BELOW.

1014.2 HEIGHT HANDRAIL HEIGHT, MEASURED ABOVE STAIR TREAD NOSINGS, SHALL BE UNIFORM, NOT LESS THAN 34

EXC.2. WHERE HANDRAIL FITTINGS OR BENDINGS ARE USED TO PROVIDE CONTINOUS TRANSITION BETWEEN FLIGHTS, TRANSITION AT WINDER TREADS, TRANSITION FROM HANDRAIL TO GUARD, OR WHERE USED AT AT THE START OF A FLIGHT, THE HANDRAIL HEIGHT AT THE FITTINGS OR BENDINGS SHALL BE PERMITTED TO EXCEED THE MAXIMUM HEIGHT.

HANDRAILS WITHIN DWELLING UNITS ARE PERMITTED TO BE INTERRUPTED BY A NEWEL POST AT A TURN OR LANDING. WITHIN A DWELLING UNIT, THE USE OF A VOLUTE, TURNOUT, STARTING EASIGN OR STARTING NEWL IS ALLOWED OVER THE LOWEST TREAD.

WITHIN ANY FLIGHT OF STAIRS SHALL NOT EXCEED THE SMALLEST BY MORE THAN 3/8 INCH.

1011.5.5 NOSING AND RISER PROFILE NOSINGS SHALL HAVE A CURVATURE OR BEVEL OF NOT LESS THAN 1/16 INCH BUT NOT MORE THAN 9/16


1011.11 HANDRAILS STAIRWAYS WITHIN DWELLING UNITS ARE PERMITTED TO HAVE A HANDRAIL ON ONE SIDE ONLY. 1014 HANDRAILS

INCHES AND NOT MORE THAN 38 INCHES.

1014.4 CONTINUITY

1014.7 CLEARANCE CLEAR SPACE BETWEEN A HANDRAIL AND WALL OR OTHER SURFACE SHALL BE NOT LESS THAN 1 1/2

INCHES. A HANDRAIL AND A WALL OR OTHER SURFACE ADJACENT TO THE HANDRAIL SHALL BE FREE OF ANY SHARP OR ABRASIVE ELEMENTS.

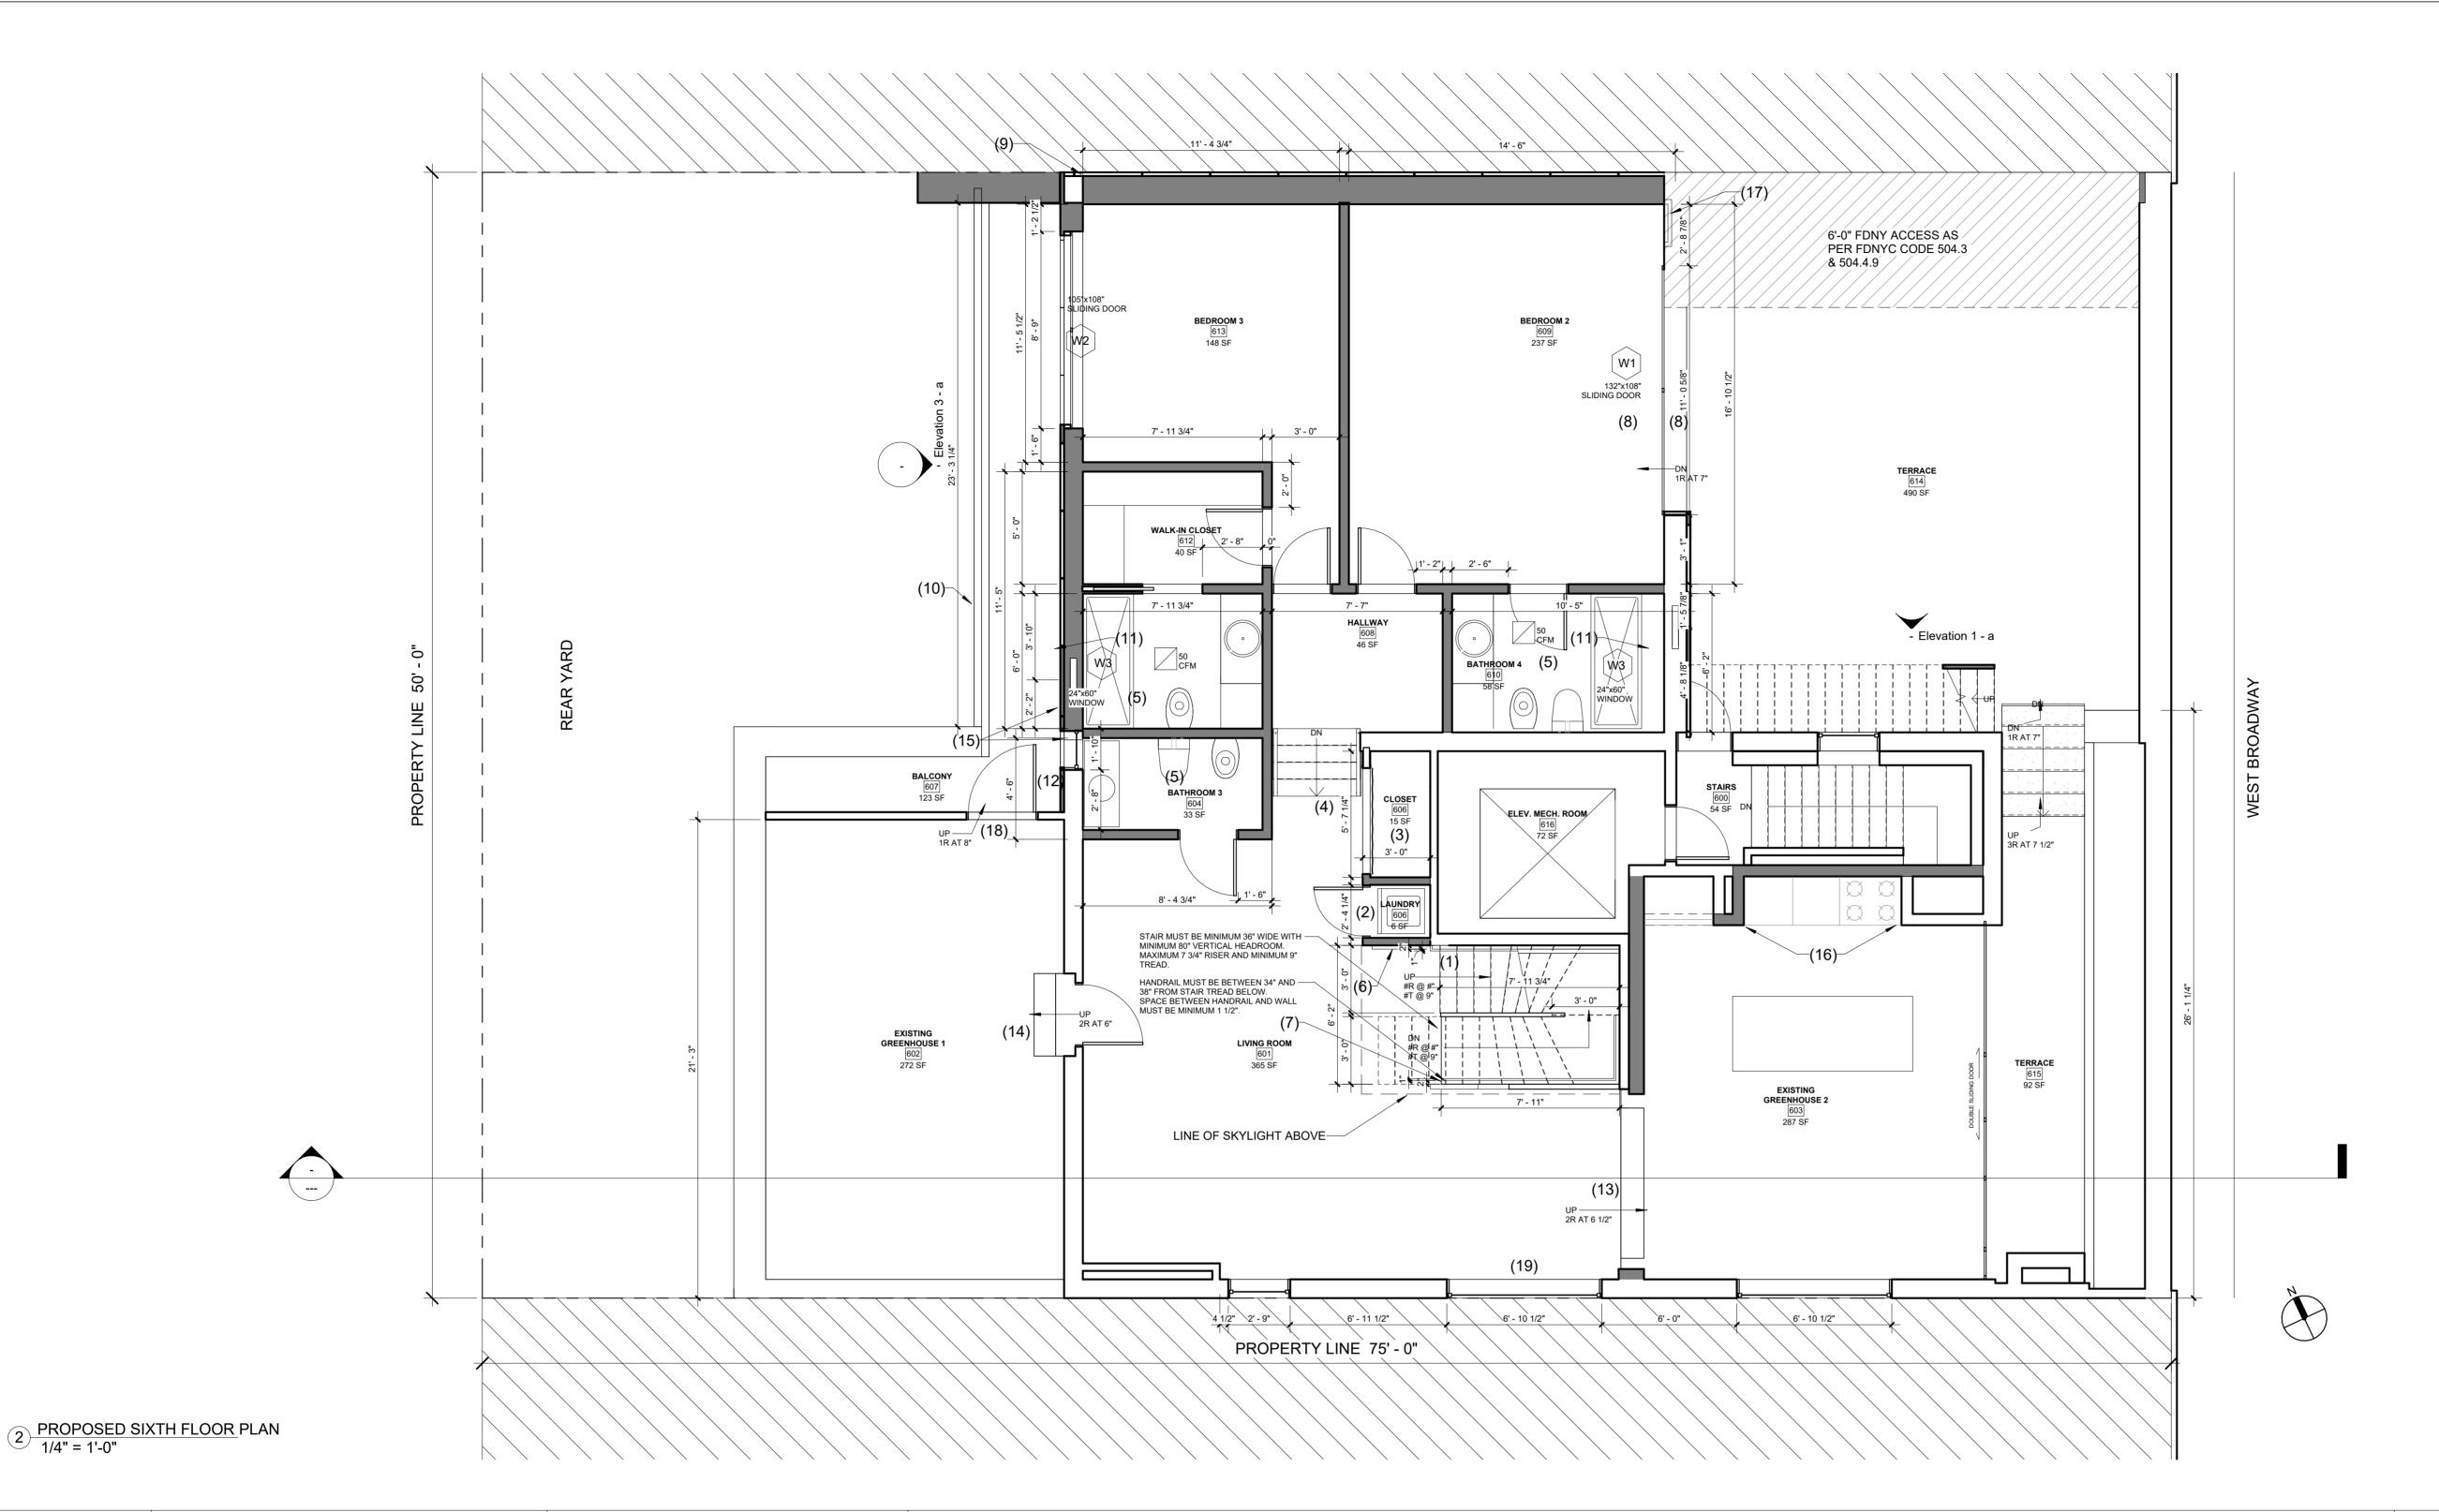

-- DEMOLITION 2. GC TO PROTECT ALL EXISTING FLOORS AND WALLS. NEW POSITION OF LAUNDRY MACHINES. EXISTING PARTITION TO REMAIN NEW PARTITION 3. NEW CLOSET. PARTITION WALL TO BE FLUSH WITH WALL 3.GC TO ISOLATE FLOOR AND CEILING WITH PLASTIC ADJACENT TO STAIR. 4. METAL STEPS TO NEW ADDITION. 5. NEW W/C AND HAND SINK. 6. RELOCATION OF EXISTING E.C PANEL. 7. NEW FLOOR OPENING TO MATCH SIZE NEEDED FOR NEW STAIR. (6'-2" x 7'-11") 8. NEW FLOOR TO BE FLUSH WITH EXISTING TERRACE FLOOR. 9. EXISTING FENCE AROUND TERRACE PERIMETER TO BE REMOVED AND REPLACED WITH NEW PARTITION WALLS. 10. EXISTING FENCE TO BE REMOVED AND REPLACED WITH BALCONY HALFWALL. 11. BATHROOM WINDOW SILL HEIGHT 5'-0" ABOVE FINISH FLOOR. 12. NEW BATHROOM WINDOW. 13. STEP LEADING TO EXISTING GREENHOUSE 1 SPACE. 14. STEP LEADING TO EXISTING OFFICE/GREENHOUSE 2 SPACE. 15. ALIGN NEW WALL WITH EXISTING. 16. NEW PARTITION WALLS ALIGNED WITH EXISTING. 17. FDNY SHIP LADDER ACCESS TO NEW SPACE ROOF.

PROPOSED WORK KEY NOTES:

1. NEW INTERIOR STAIRCASE TO ROOF.

18. STEP FROM EXISTING GREENHOUSE 1 SPACE TO TERRACE.

19. NEW LARGER WINDOW OVER EXISTING WINDOW OPENING.

LEGEND

GENERAL CONSTRUCTION NOTES: STAIR NOTES:

SHEATHING.

ALL INTERIOR STAIRS COMPLY WITH THE FOLLOWING CODE: 1. GC TO PREVENT ANY DAMAGE TO FLOORS BELOW.

NYCBC 2022 1011 STAIRWAYS

1011.2 WIDTH AND CAPACITY THE MINIMUM WIDTH SHALL BE NOT LESS THN 44 INCHES

EXC 1.1. A WIDTH OF NOT LESS THAN 36 INCHES SHALL BE PERMITTED IN A STAIRWAY THAT SERVES AN OCCUPANT LOAD OF 50 OR LESS CUMULATIVE FOR ALL STORIES.

1011.3 HEADROOM STAIRWASY SHALL HAVE A HEADROOM CLEARANCE OF NOT LESS THAN 84 INCHES MEASURED

VERTICALLY FROM A LINE CONNECTING THE EDGE OF NOSINGS. THE MINIMUM CLEARANCE SHALL BE MAINTAINED THE FULL WIDTH OF THE STAIRWAY AND LANDING.

EXC 1. IN GROUP R-2 AND R-3 CCUPANCIES STAIRWAYS SHALL HAVE A HEADROOM CLEARANCE OF NOT LESS THAN 80 INCHES.

THE WALKLINE ACROSS WINDER TREADS SHALL BE CONCENTRIC TO THE DIRERCTION OF TRAVEL THROUGH THE TURN AND LOCATED 12 INCHES FROM THE SIDE WHERE WINDERS ARE NARROWER. THE 12 INCH DIMENSION SHALL BE MEASURED FROM THE WIDEST POINT OF THE CLEAR STAIR WIDTH AT THE WALKING SURFACE OF THE WINDER, WHERE WINDERS ARE ADJACENT WITHIN THE FLIGHT, THE POINT OF THE WIDEST CLEAR STAIR WIDTH OF THE ADJACENT WINDERS SHALL BE USED.

1011.5.2 RISER HEIGHT AND TREAD DEPTH STAIR RISER HEIGHTS SHALL BE 7 INCHES MAXIMUM AND 4 INCHES MINIMUM. THE RISER HEIGHT SHALL BE MEASURED VERTICALLY BETWEEN THE NOSINGS OF ADJACENT TREADS.

RENCTANGULAR TREAD DEPTHS SHALL BE 11 INCHES MINIMUM MEASURED HORIZONTALLY BETWEEN THE VERTICAL PLANES OF THE FOREMOST PROJECTION OF ADJACENT TREADS AND AT A RIGHT ANGLE TO THE TREAD'S NOSING.

EXC. 3.1. IN GROUP R-2 OCCUPANCIES THE SUM OF TWO RISERS PLUS ONE TREAD EXCLUSIVE OF NOSING SHALL BE NOT LESS THAN 24 INCHES NOR MORE THAN 25 1/2 INCHES.

EXC.3.2. IN GROUP R-2 OCCUPANCIES THE MAXIMUM RISER HEIGHT SHALL BE 7 3/4 INCHES AND THE MINIMUM TREAD DEPTH SHALL BE 9 1/2 INCHES PLUS NOSING. TREADS MAY BE UNDERCUT A DISTANCE EQUAL TO THE NOSING. A NOSING NOT LESS THAN 3/4 INCH BUT NO MORE THAN 1 1/4 INCHES SHALL BE PROVIDED ON STAIRWAYS WITH SOLID RISERS WHERE THE TREAD DEPTH IS

LESS THAN 11 INCHES. EXC.5. WITHIN GROUP R-2 OCCUPANCIES WINDERS SHALL HAVE A MINIMUM TREAD DEPTH OF 10 INCHES MEASURED HORIZONTALLY BETWEEN THE VERTICAL PLANES OF THE FOREMOST PROJECTION OF ADJACENT TREADS AND AT A RIGHT ANGLE TO THE TREAD'S LEADING EDGE, WHEN MEASURED AT A POINT 12 INCHES FROM THE SIDE WHERE THE TREADS ARE NARROWER. WINDER TREADS HAVE TO HAVE A MINIMUM TREAD DEPTH OF 6 INCHES AT ANY POINT. WITHIN ANY FLIGHT OF STAIRS, THE GREATEST WINDER TREAD DEPTH AT THE 12 INCH WALK LINE SHALL NOT EXCEED THE SMALLEST BY MOE THAN 3/8 INCH.

1011.5.4 DIMENSIONAL UNIFORMITY STAIR TREADS AND RISERS SHALL BE OF UNIFORM SIZE AND SHAPE. THE TOLERANCE BETWEEN THE LARGEST AND SMALLEST RISER HEIGHT OR BETWEEN THE LARGEST AND SMALLEST TREAD DEPTH SHALL NOT EXCEED 3/8 INCH IN ANY FLIGHT OF STAIRS. THE GREATEST WNDER TREAD DEPTH AT THE WALKLINE WITHIN ANY FLIGHT OF STAIRS SHALL NOT EXCEED THE SMALLEST BY MORE THAN 3/8 INCH.

EXC.2. CONSISTENTLY SHAPED WNDERS, COMPLYING WITH SECTION 1011.5, DIFFERING FROM RECTANGULAR TREADS IN THE SAME FLIGHT OF STAIRS. 1011.5.5 NOSING AND RISER PROFILE

NOSINGS SHALL HAVE A CURVATURE OR BEVEL OF NOT LESS THAN 1/16 INCH BUT NOT MORE THAN 9/16 INCH FROM THE FOREMOST PROJECTION OF THE TREAD. RISERS SHALL BE SOLID AND VERTICAL OR SLOPED UNDER THE TREAD ABOVE FROM THE UNDERSIDE OF THE NOSING ABOVE AT AN ANGLE NOT MORE THAN 30 DEGREES FROM THE VERTICAL.

1011.5.5.1 NOSING PROJECTION SIZE THE LEADING EDGE (NOSINGS) OF TREADS SHALL PROJECT NOT MORE THAN 1 1/4 INCHES BEYOND THE 1011.11 HANDRAILS

STAIRWAYS WITHIN DWELLING UNITS ARE PERMITTED TO HAVE A HANDRAIL ON ONE SIDE ONLY.

1014.2 HEIGHT HANDRAIL HEIGHT, MEASURED ABOVE STAIR TREAD NOSINGS, SHALL BE UNIFORM, NOT LESS THAN 34

INCHES AND NOT MORE THAN 38 INCHES. EXC.2. WHERE HANDRAIL FITTINGS OR BENDINGS ARE USED TO PROVIDE CONTINOUS TRANSITION BETWEEN

FLIGHTS, TRANSITION AT WINDER TREADS, TRANSITION FROM HANDRAIL TO GUARD, OR WHERE USED AT AT THE START OF A FLIGHT, THE HANDRAIL HEIGHT AT THE FITTINGS OR BENDINGS SHALL BE PERMITTED TO EXCEED THE MAXIMUM HEIGHT. 1014.4 CONTINUITY

HANDRAILS WITHIN DWELLING UNITS ARE PERMITTED TO BE INTERRUPTED BY A NEWEL POST AT A TURN OR LANDING. WITHIN A DWELLING UNIT. THE USE OF A VOLUTE. TURNOUT, STARTING EASIGN OR STARTING NEWL IS ALLOWED OVER THE LOWEST TREAD. 1014.7 CLEARANCE

CLEAR SPACE BETWEEN A HANDRAIL AND WALL OR OTHER SURFACE SHALL BE NOT LESS THAN 1 1/2 INCHES. A HANDRAIL AND A WALL OR OTHER SURFACE ADJACENT TO THE HANDRAIL SHALL BE FREE OF ANY SHARP OR ABRASIVE ELEMENTS.

FIRE DEPARTMENT NOTES

1. AS PER FDNY 504.4.4 A CLEAR PATH OF NOT LESS THAN 6' HORIZONTAL WIDTH OF 9' IN HEIGHT SHALL BE PROVIDED FROM THE FRONT OF THE BUILDING TO THE REAR OF THE BUILING AND FROM ONE SIDE OF THE BUILDING TO THE OTHER . SUCH PATH SHALL BE ACCESSIBLE FROM EACH ROOFTOP PERIMETER ACCESS LANDING REQUIERED PERSUANT TO FC504.4.3 IT SHALL AFFORD ACCESS TO THE BULKHEAD DOOR AND ANY ACCESS LADDERS, SKYLIGHTS, SCUTTLES AND SHAFTS. A CONDUIT OR PIPE MAY CROSS SUCH PATH IN ACCORDANCE WITH FC504.4.7 A FIXED LADDER OR OTHER APPROVED MEANS SHALL BE PROVIDED TO AFFORD ACCESS ALONG THE CLEAR PATH RFROM ONE ROOF LEVEL TO THE NEXT, INCLUDING THE BULKHEAD.

2. AS PER 504.4.3AN ACCESS LANDING 6' IN ANY DIMENSINON CONNECTED TO THE CLEAR PATH IS REQUIERD.

CONTACT: STEFANO MORISI R.A. T: 1-917-960-3961 E: INFO@STUDIODYO.COM

NEW YORK, NY 10001 SUITE# 902A

PROJECT INFORMATION:

ARCHITECT OF RECORD:

design office DY-O DESIGN OFFICE 143 WEST 29 STREET

GROSS FLOOR AREA: 15,204SF

460-462 WEST BROADWAY NEW YORK, NY 10012

06/23/2022

ADDRESS:

DATE:

Architect Monica Cardin Fontana

architetto@cardinfontana.it - www.cardinfontana.

DESIGN ARCHITECT:

VIA MARCONI, 43 CASALECCHIO DI RENO, (BO) ARCHITETTO@CARDINFONTANA.IT WWW.CARDINFONTANA.IT

OWNER:

CRISTINA CALORI CCNY REALTY, INC. 444 MADISON AVE **NEW YOR, NY 10022**

DOB JOB #: 120070485

DISCLAIMER:

The architect shall not have control or charge of and shall not be responsible for construction means, methods, deviations, techniques, sequences or procedures, or for safety precautions and programs in connection with the work, for the acts or ommisions of the contractor, sub-contractors, or any other persons performing any of the work, or for the failure of any of them to carry out the work in accordance with the contract documents. written dimensions on this drawing shall have precedence over scaled dimensions. Contractors shall verify and be responsible for all dimensions and conditions on the job and this office must be notified of any variations from the dimensions and conditions shown by these drawings. shop details must be submitted to this office for review before proceeding with fabrication. not valid for construction unless signed and sealed by the architect and

 Rev
 Date
 Description


 1
 12/11/2023
 DOB Submission 1

approved by the department of buildings.

SHEET TITLE:

PROPOSED SIXTH



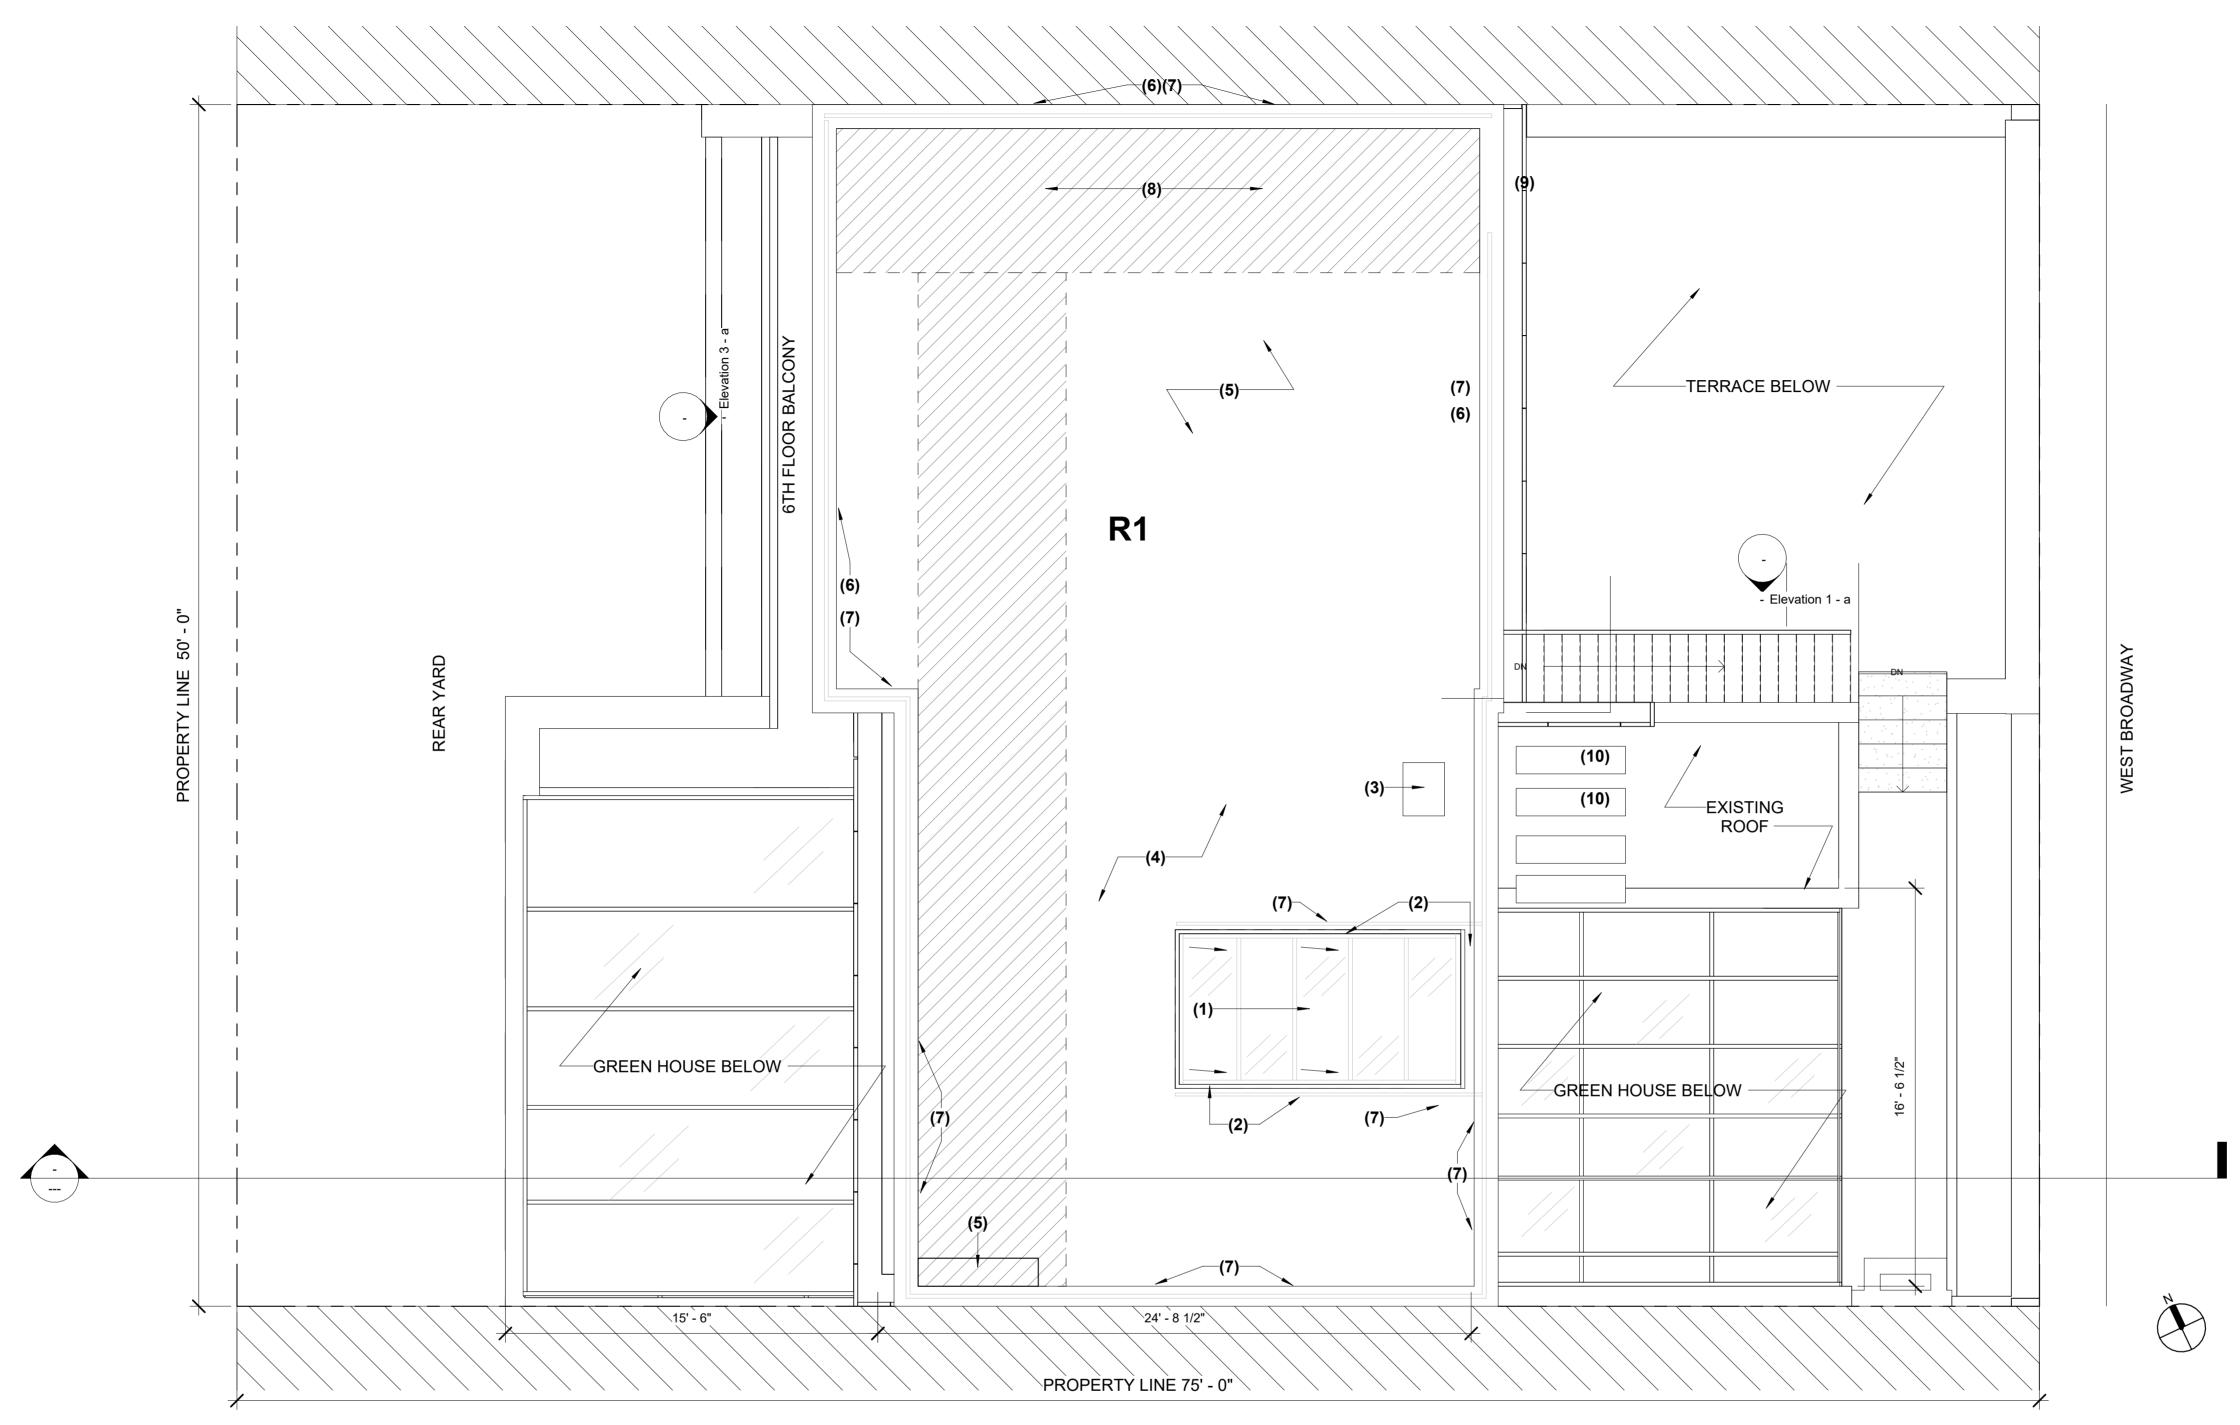

PROPOSED ROOF PLAN
1/4" = 1'-0"

LEGEND PROPOSED WORK KEY NOTES: - DEMOLITION 1. NEW RETRACTABLE SKY LYGHT MODEL T.B.D EXISTING PARTITION TO REMAIN 2. NEW CURB TO BE WATERPROOF AND TO FINISH AT EXISTING FLOOR HEIGHT NEW PARTITION 3. NEW POSTION OF DUCT 4. EXISTING WOOD COMPOSITE FLOOR TO REMAIN 5. NEW WOOD COMPOSITE FLOOR TO MATCH EXISTING IN SIZE AND COLOR (APRX 645 SF) 6. NEW PARAPET TO MATCH IN HEIGHT EXISTING ADJACENT WALL 7. NEW GLASS RAILING TO MATCH EXISING IN 8. NEW FDNY ROOF ACCESS PATH AS PER 504.4.4 9.NEW SHIP LADDER 10. NEW HVAC SPLIT SYSTEM (36,000 BTU CONDENSER FUJITSU AOU36RLXFZ1)

GENERAL CONSTRUCTION NOTES:

- ARTIST (JLWQA)
- 2. ROOF ENLARGEMENT TO BE SAME HEIGHT AS EXISTING 6TH FLOOR ROOF

1. EXISTING BUILDING IS JOINT LIVING WORK QUARTERS FOR

3. ENLARGEMENT FOR OFFICE USE

4. NO CHANGE TO LIVING AREAS THROUGHOUT

FIRE DEPARTMENT NOTES

1. AS PER FDNY 504.4.4 A CLEAR PATH OF NOT LESS THAN 6' HORIZONTAL WIDTH OF 9' IN HEIGHT SHALL BE PROVIDED FROM THE FRONT OF THE BUILDING TO THE REAR OF THE BUILING AND FROM ONE SIDE OF THE BUILDING TO THE OTHER . SUCH PATH SHALL BE ACCESSIBLE FROM EACH ROOFTOP PERIMETER ACCESS LANDING REQUIERED PERSUANT TO FC504.4.3 IT SHALL AFFORD ACCESS TO THE BULKHEAD DOOR AND ANY ACCESS LADDERS, SKYLIGHTS, SCUTTLES AND SHAFTS. A CONDUIT OR PIPE MAY CROSS SUCH PATH IN ACCORDANCE WITH FC504.4.7 A FIXED LADDER OR OTHER APPROVED MEANS SHALL BE PROVIDED TO AFFORD ACCESS ALONG THE CLEAR PATH RFROM ONE ROOF

2. AS PER 504.4.3AN ACCESS LANDING 6' IN ANY DIMENSINON CONNECTED TO THE CLEAR PATH IS REQUIERD.

LEVEL TO THE NEXT, INCLUDING THE BULKHEAD.

PROJECT INFORMATION:

ADDRESS: 460-462 WEST BROADWAY NEW YORK, NY 10012

DATE: 06/23/2022

GROSS FLOOR AREA: 15,204SF

ARCHITECT OF RECORD:

DY-O DESIGN OFFICE 143 WEST 29 STREET NEW YORK, NY 10001 SUITE# 902A

CONTACT: STEFANO MORISI R.A. T: 1-917-960-3961 E: INFO@STUDIODYO.COM

DESIGN ARCHITECT:

Architect Monica Cardin Fontana architetto@cardinfontana.it - www.cardinfontano.i

VIA MARCONI, 43 CASALECCHIO DI RENO, (BO) ARCHITETTO@CARDINFONTANA.IT WWW.CARDINFONTANA.IT

OWNER:

CRISTINA CALORI CCNY REALTY, INC. 444 MADISON AVE NEW YOR, NY 10022

DOB JOB #: 120070485

DISCLAIMER:

The architect shall not have control or charge of and shall not be responsible for construction means, methods, deviations, techniques, sequences or procedures, or for safety precautions and programs in connection with the work, for the acts or ommisions of the contractor, sub-contractors, or any other persons performing any of the work, or for the failure of any of them to carry out the work in accordance with the contract documents. written dimensions on this drawing shall have precedence over scaled dimensions. Contractors shall verify and be responsible for all dimensions and conditions on the job and this office must be notified of any variations from the dimensions and conditions shown by these drawings. shop details must be submitted to this office for review before proceeding with fabrication. not valid for construction unless signed and sealed by the architect and approved by the department of buildings.

 Rev
 Date
 Description
 Issued By
 Issued To

 1
 12/11/2023
 DOB Submission 1
 DYO
 DOB

SHEET TITLE:

PROPOSED ROOF **PLAN**

SEAL AND SIGNATURE




CHECKED BY SM

DATE MM/DD/YYYY

DYO NO. 220809

DRAWN BY

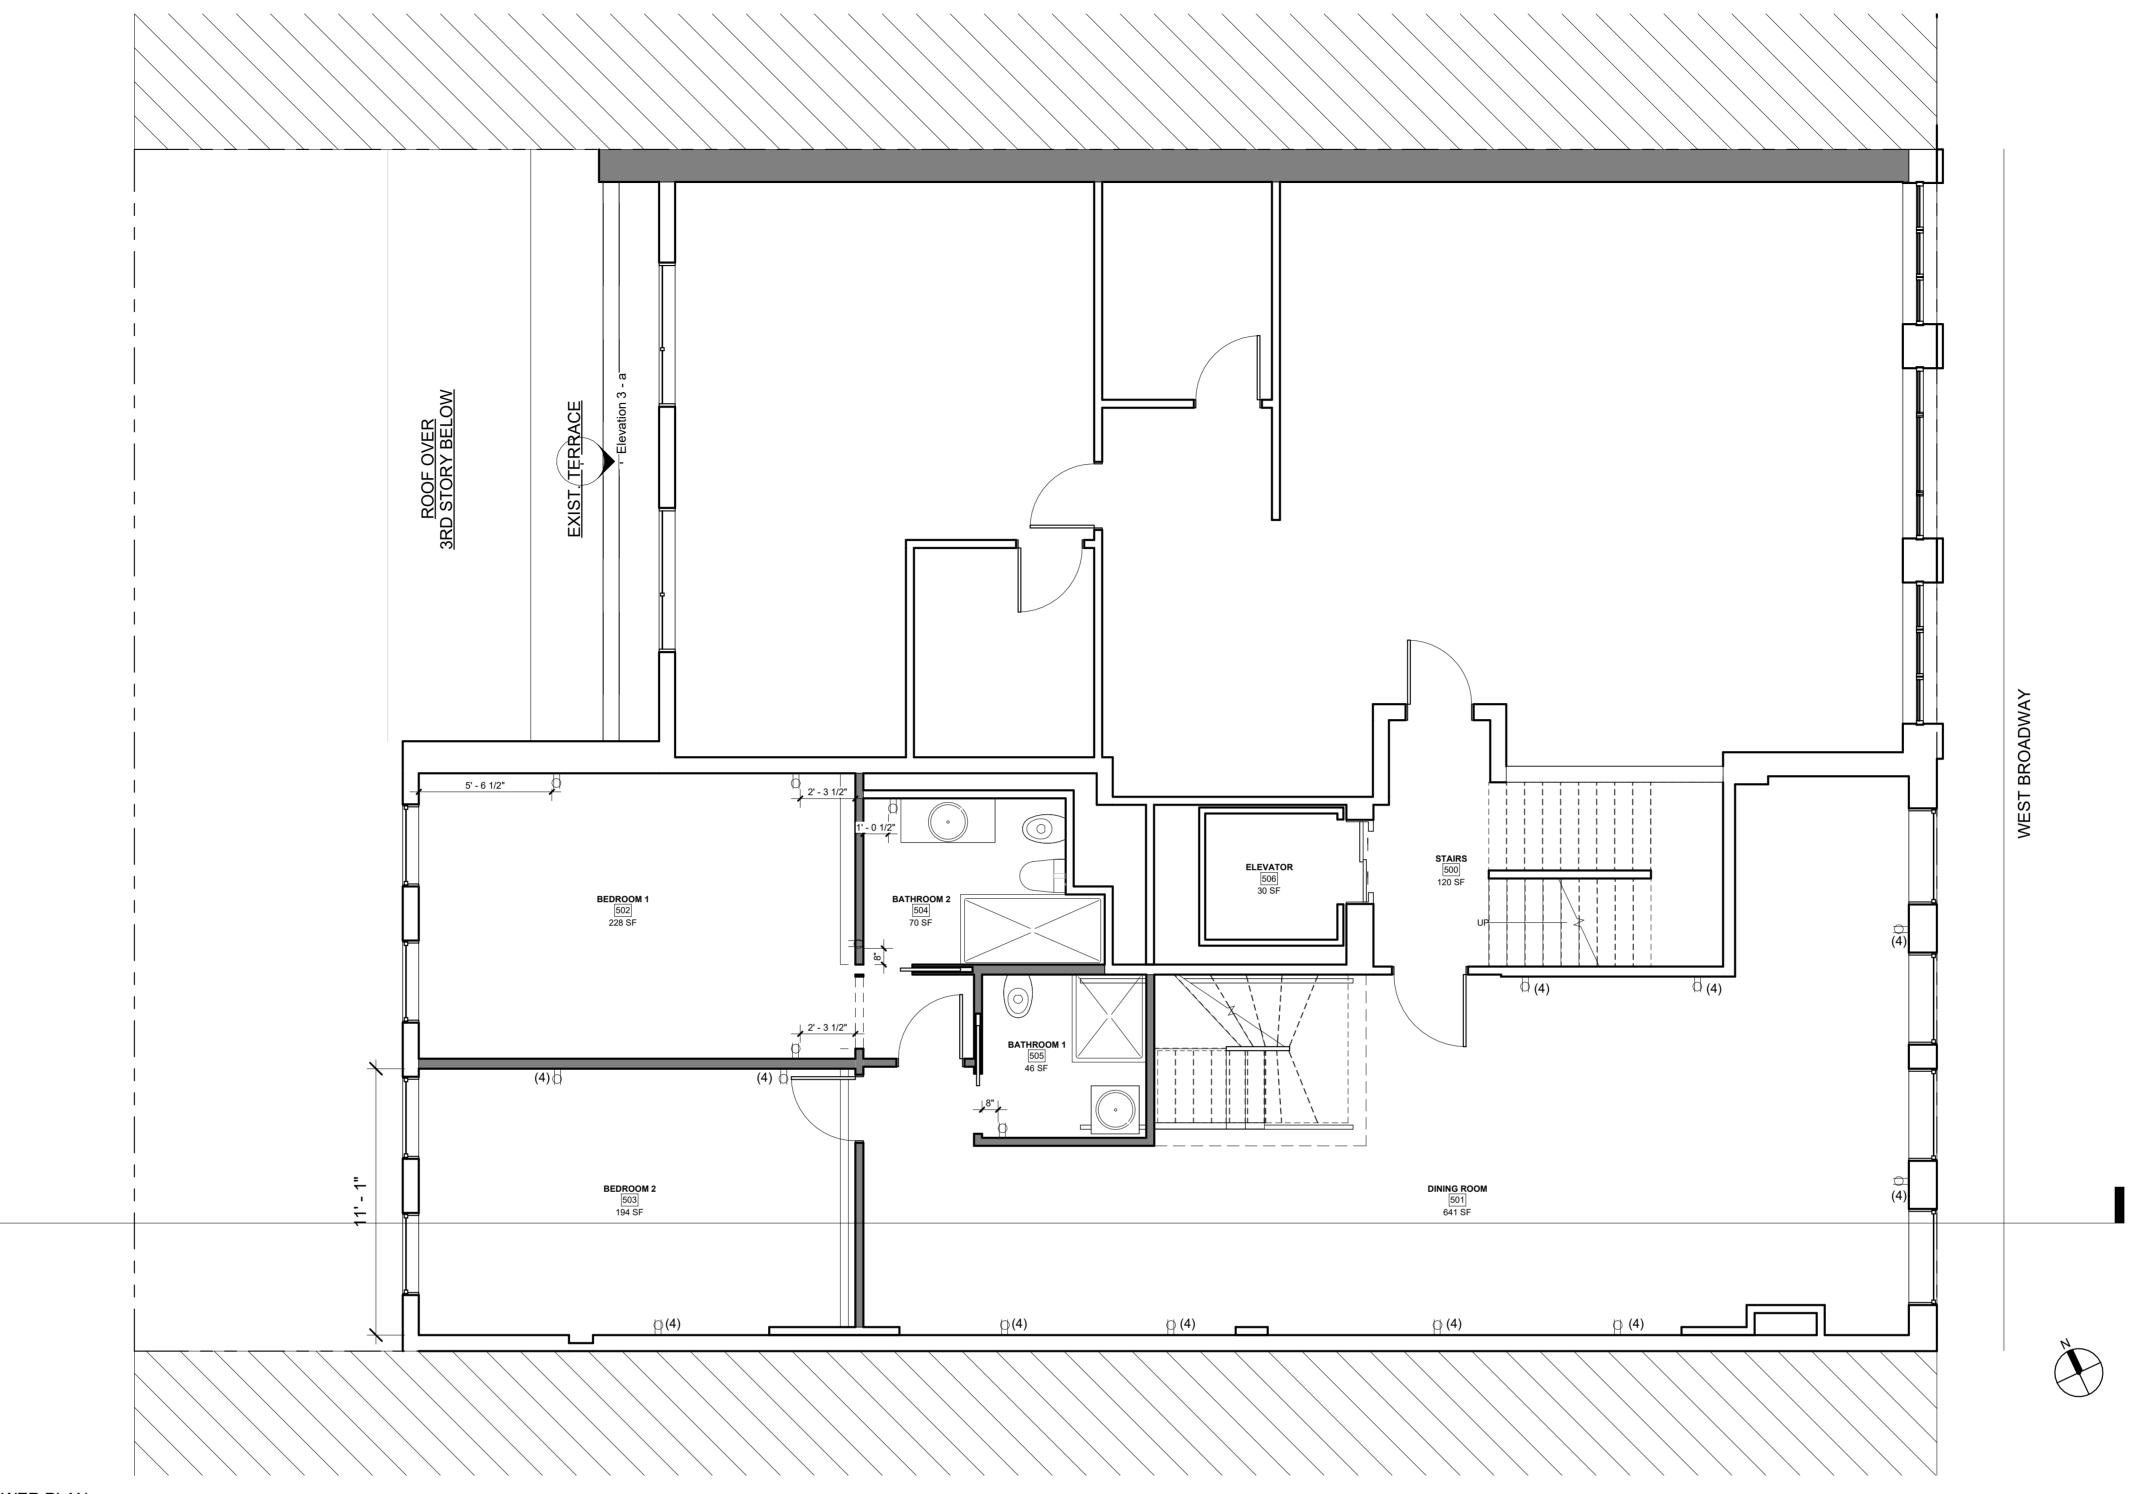

1) FIFTH FLOOR PROPOSED POWER PLAN 1/4" = 1'-0"

PROPOSED RCP AND POWER PLAN NOTES:

BUILDING CODE AND DOES NOT COMPROMISE THE RATED CEILING.

2. FOR ALL RELOCATED OR NEW ELECTRICAL POINTS NEW BRANCH

WIRING IS TO BE SUPPLIED BACK TO THE ELECTRICAL PANEL.

4. EXISTING OUTLETS OUTSIDE OF SCOPE OF WORK TO REMAIN.

3. APPLIANCE TO HAVE A DEDICATED CIRCUIT.

LEGEND MASTER SWITCH OFF SWITCH CONTROLLING DESIGNATE CIRCUIT LOCAL SWITCH DOUBLE SWITCH DIMMER SWITCH DENOTES CIRCUIT IN NUMBER IN AREA

DENOTES LIGHT FIXTURES ON SAME CIRCUIT **EXIT SIGN** OCCUPANT SENSOR CONTROL DAYLIGHT RESPONSIVE CONTROL

ENERGY COMPLIANCE NOTES:

1. RECESSED LIGHT FIXTURES PENETRATING THE BUILDING THERMAL ENVELOPE SHALL BE SEALED TO 1. PROPOSED LIGHTING WITHIN THE RATED CEILING CONFORMS TO NYC THE AIR BARRIER AS PER 2020ECC CHAPTER 4, TABLE R402.4.1.1 AIR BARRIER AND INSULATION

> 2. RECESSED LIGHT FIXTURES PENETRATING THE BUILDING THERMAL ENVELOPE SHALL BE AIR TIGHT AND IC RATED AS PER 2020ECC CHAPTER 4, TABLE R402.4.1.1 AIR BARRIER AND INSULATION INSTALLATION

PROJECT INFORMATION:

ADDRESS: 460-462 WEST BROADWAY NEW YORK, NY 10012

DATE: 06/23/2022

GROSS FLOOR AREA: 15,204SF

ARCHITECT OF RECORD:



DY-O DESIGN OFFICE 143 WEST 29 STREET NEW YORK, NY 10001 SUITE# 902A

CONTACT: STEFANO MORISI R.A. T: 1-917-960-3961 E: INFO@STUDIODYO.COM

DESIGN ARCHITECT:

Architect Monica Cardin Fontana architetto@cardinfontana.it - www.cardinfontana.it

VIA MARCONI, 43 CASALECCHIO DI RENO, (BO) ARCHITETTO@CARDINFONTANA.IT WWW.CARDINFONTANA.IT

OWNER:

CRISTINA CALORI CCNY REALTY, INC. 444 MADISON AVE NEW YOR, NY 10022

DOB JOB #: 120070485

DISCLAIMER:


The architect shall not have control or charge of and shall not be responsible for construction means, methods, deviations, techniques, sequences or procedures, or for safety precautions and programs in connection with the work, for the acts or ommisions of the contractor, sub-contractors, or any other persons performing any of the work, or for the failure of any of them to carry out the work in accordance with the contract documents. written dimensions on this drawing shall have precedence over scaled dimensions. Contractors shall verify and be responsible for all dimensions and conditions on the job and this office must be notified of any variations from the dimensions and conditions shown by these drawings. shop details must be submitted to this office for review before proceeding with fabrication. not valid for construction unless signed and sealed by the architect and approved by the department of buildings.

 Rev
 Date
 Description
 Issued By
 Issued To

 1
 12/11/2023
 DOB Submission 1
 DYO
 DOB

SHEET TITLE:

5TH FLOOR PROPOSED POWER PLAN

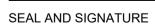




DRAWN BY CHECKED BY SM

DYO NO. 220809

DATE MM/DD/YYYY

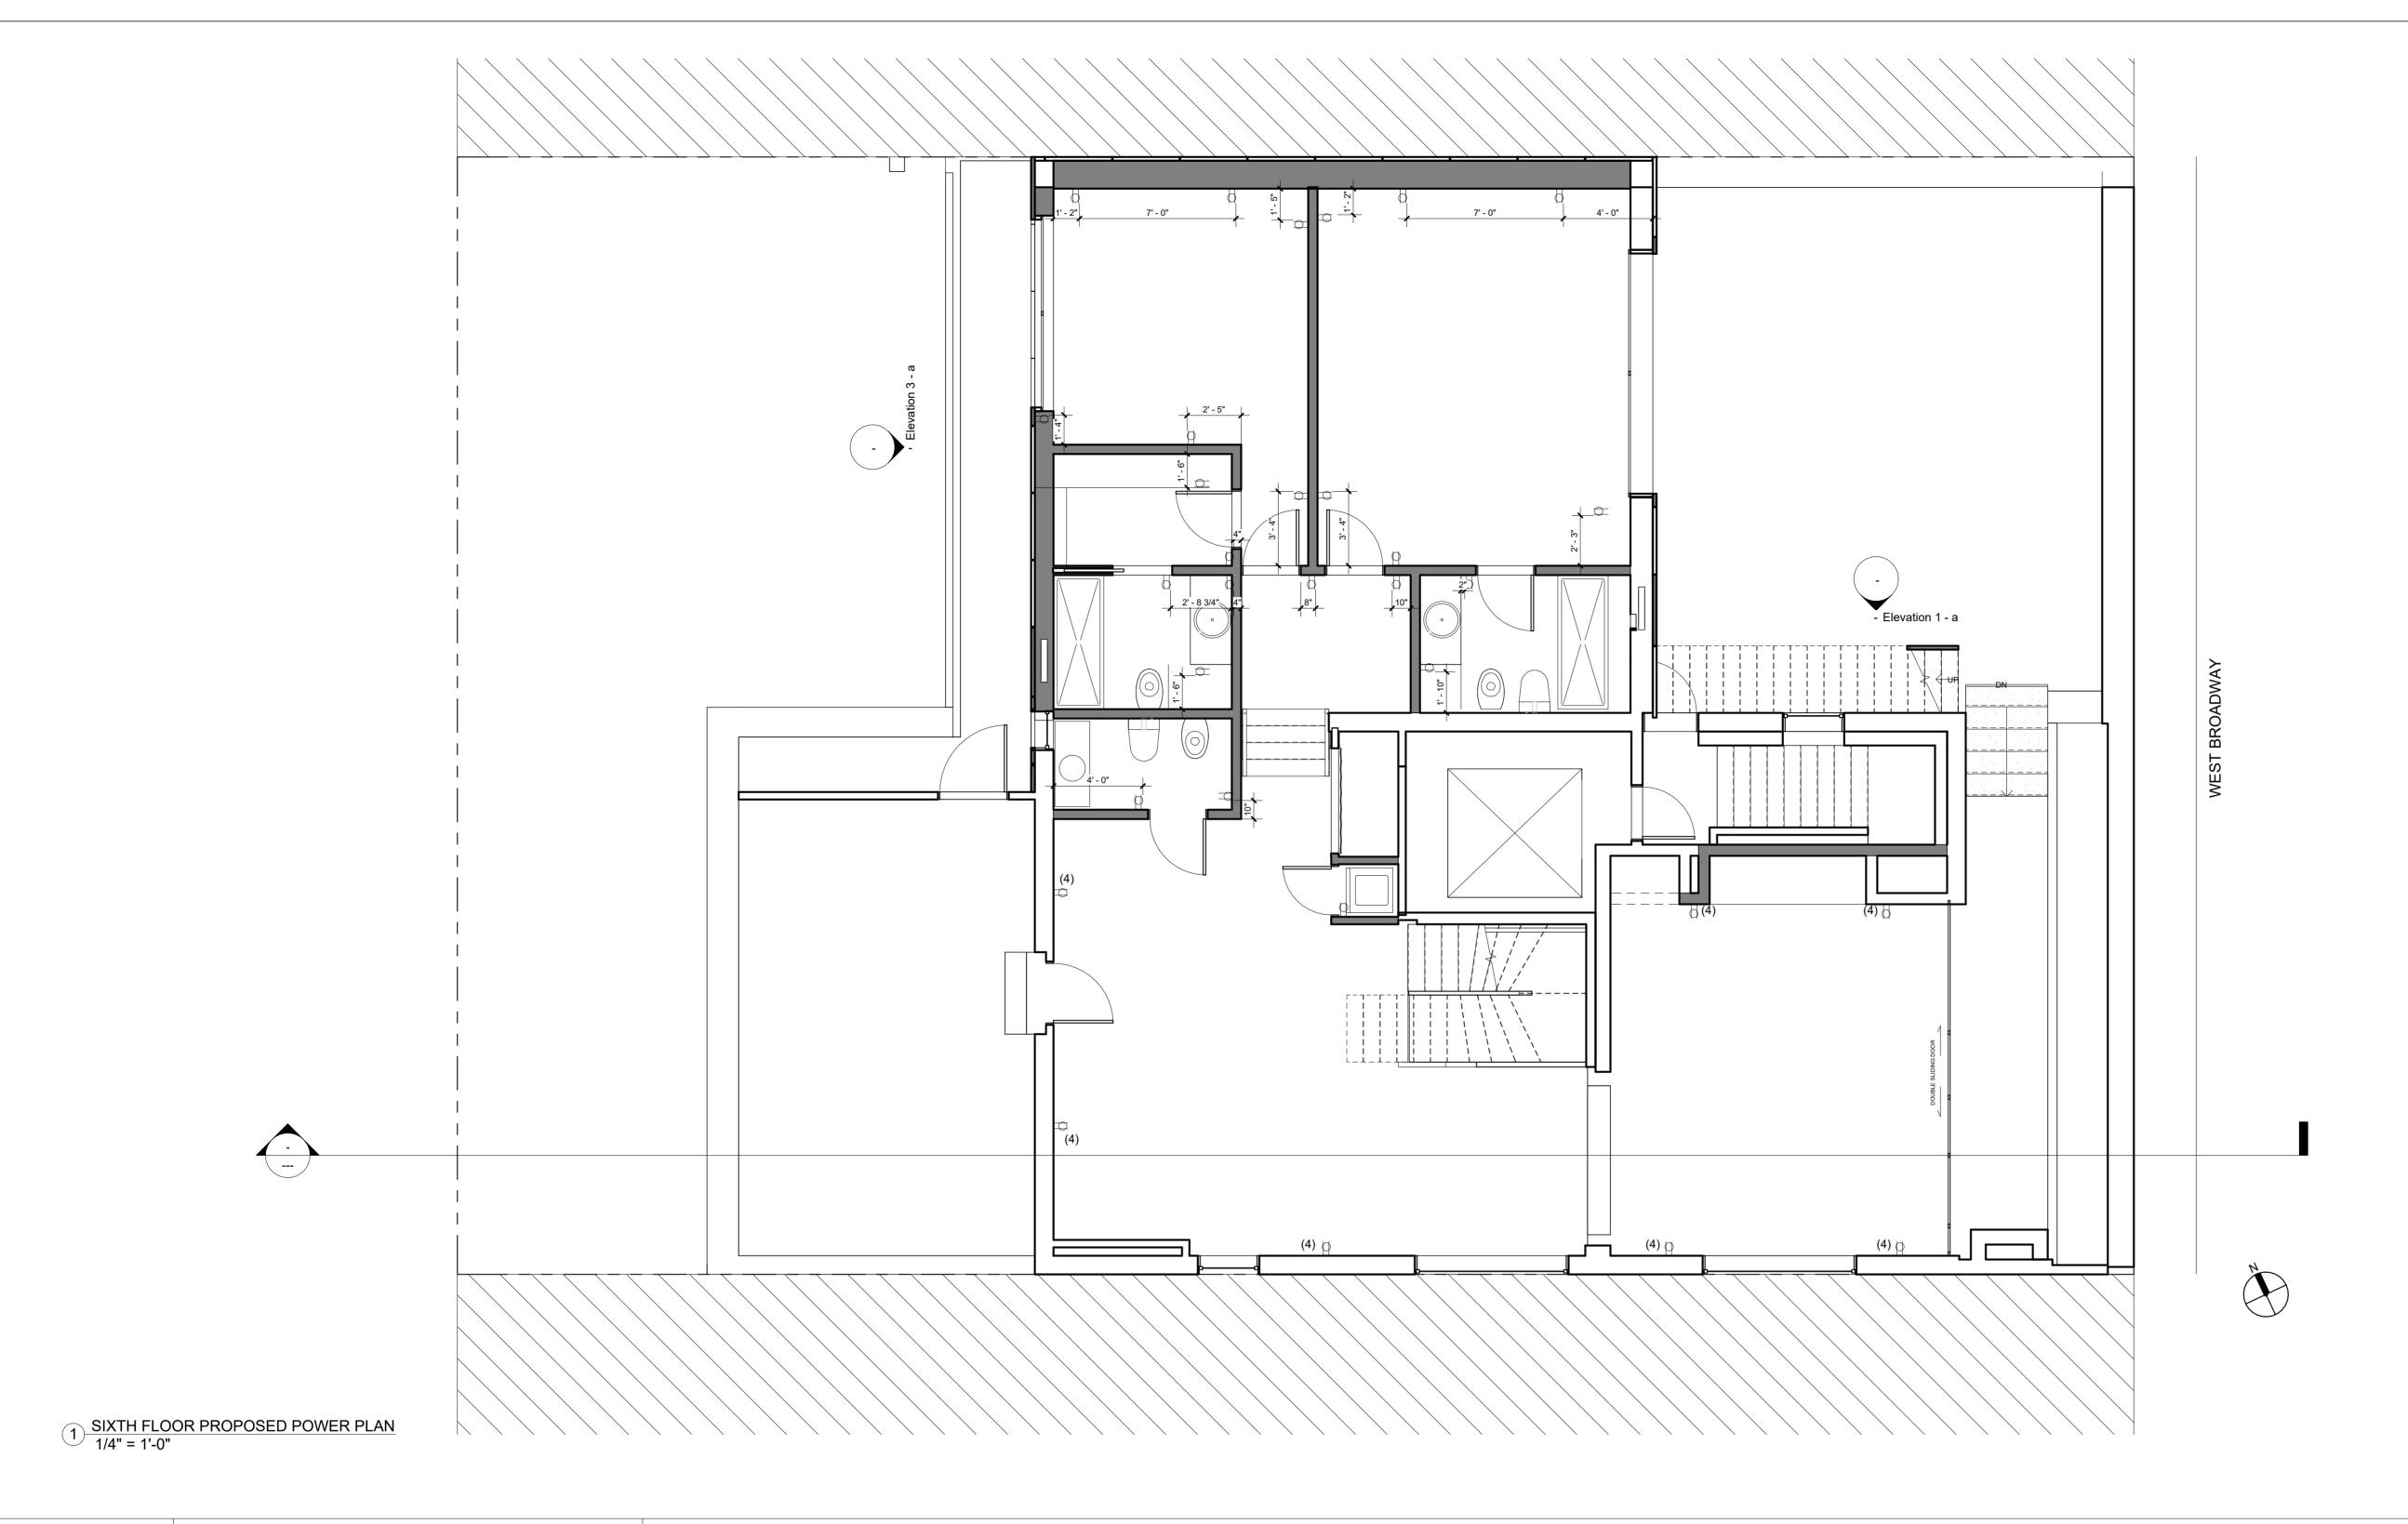

ADDRESS: 460-462 WEST BROADWAY NEW YORK, NY 10012

DATE: 06/23/2022

GROSS FLOOR AREA: 15,204SF

ARCHITECT OF RECORD:

design office

DY-O DESIGN OFFICE 143 WEST 29 STREET NEW YORK, NY 10001 SUITE# 902A

CONTACT: STEFANO MORISI R.A. T: 1-917-960-3961 E: INFO@STUDIODYO.COM

DESIGN ARCHITECT:

Architect Monica Cardin Fontana architetto@cardinfontana.it - www.cardinfontana.it

VIA MARCONI, 43 CASALECCHIO DI RENO, (BO) ARCHITETTO@CARDINFONTANA.IT WWW.CARDINFONTANA.IT

OWNER:

CRISTINA CALORI CCNY REALTY, INC. 444 MADISON AVE **NEW YOR, NY 10022**

DOB JOB #: 120070485

DISCLAIMER:

The architect shall not have control or charge of and shall not be responsible for construction means, methods, deviations, techniques, sequences or procedures, or for safety precautions and programs in connection with the work, for the acts or ommisions of the contractor, sub-contractors, or any other persons performing any of the work, or for the failure of any of them to carry out the work in accordance with the contract documents. written dimensions on this drawing shall have precedence over scaled dimensions. Contractors shall verify and be responsible for all dimensions and conditions on the job and this office must be notified of any variations from the dimensions and conditions shown by these drawings. shop details must be submitted to this office for review before proceeding with fabrication. not valid for construction unless signed and sealed by the architect and

 Rev
 Date
 Description
 Issued By
 Issued To

 1
 12/11/2023
 DOB Submission 1
 DYO
 DOB

approved by the department of buildings.

SHEET TITLE:

6TH FLOOR PROPOSED POWER PLAN

SEAL AND SIGNATURE



DRAWN BY CHECKED BY SM

DATE MM/DD/YYYY

DYO NO. 220809



1. PROPOSED LIGHTING WITHIN THE RATED CEILING CONFORMS TO NYC BUILDING CODE AND DOES NOT COMPROMISE THE RATED CEILING.

3. APPLIANCE TO HAVE A DEDICATED CIRCUIT.

2. FOR ALL RELOCATED OR NEW ELECTRICAL POINTS NEW BRANCH WIRING IS TO BE SUPPLIED BACK TO THE ELECTRICAL PANEL.

1. RECESSED LIGHT FIXTURES PENETRATING THE BUILDING THERMAL ENVELOPE SHALL BE SEALED TO THE AIR BARRIER AS PER 2020ECC CHAPTER 4, TABLE R402.4.1.1 AIR BARRIER AND INSULATION INSTALLATION

2. RECESSED LIGHT FIXTURES PENETRATING THE BUILDING THERMAL ENVELOPE SHALL BE AIR TIGHT AND IC RATED AS PER 2020ECC CHAPTER 4, TABLE R402.4.1.1 AIR BARRIER AND INSULATION

INSTALLATION

4. EXISTING OUTLETS OUTSIDE OF SCOPE OF WORK TO REMAIN.

LEGEND

MASTER SWITCH OFF

SWITCH CONTROLLING

DESIGNATE CIRCUIT

LOCAL SWITCH

DOUBLE SWITCH

DIMMER SWITCH **DENOTES CIRCUIT** IN NUMBER IN AREA

ON SAME CIRCUIT

SENSOR CONTROL


DAYLIGHT RESPONSIVE

EXIT SIGN

OCCUPANT

CONTROL

DENOTES LIGHT FIXTURES

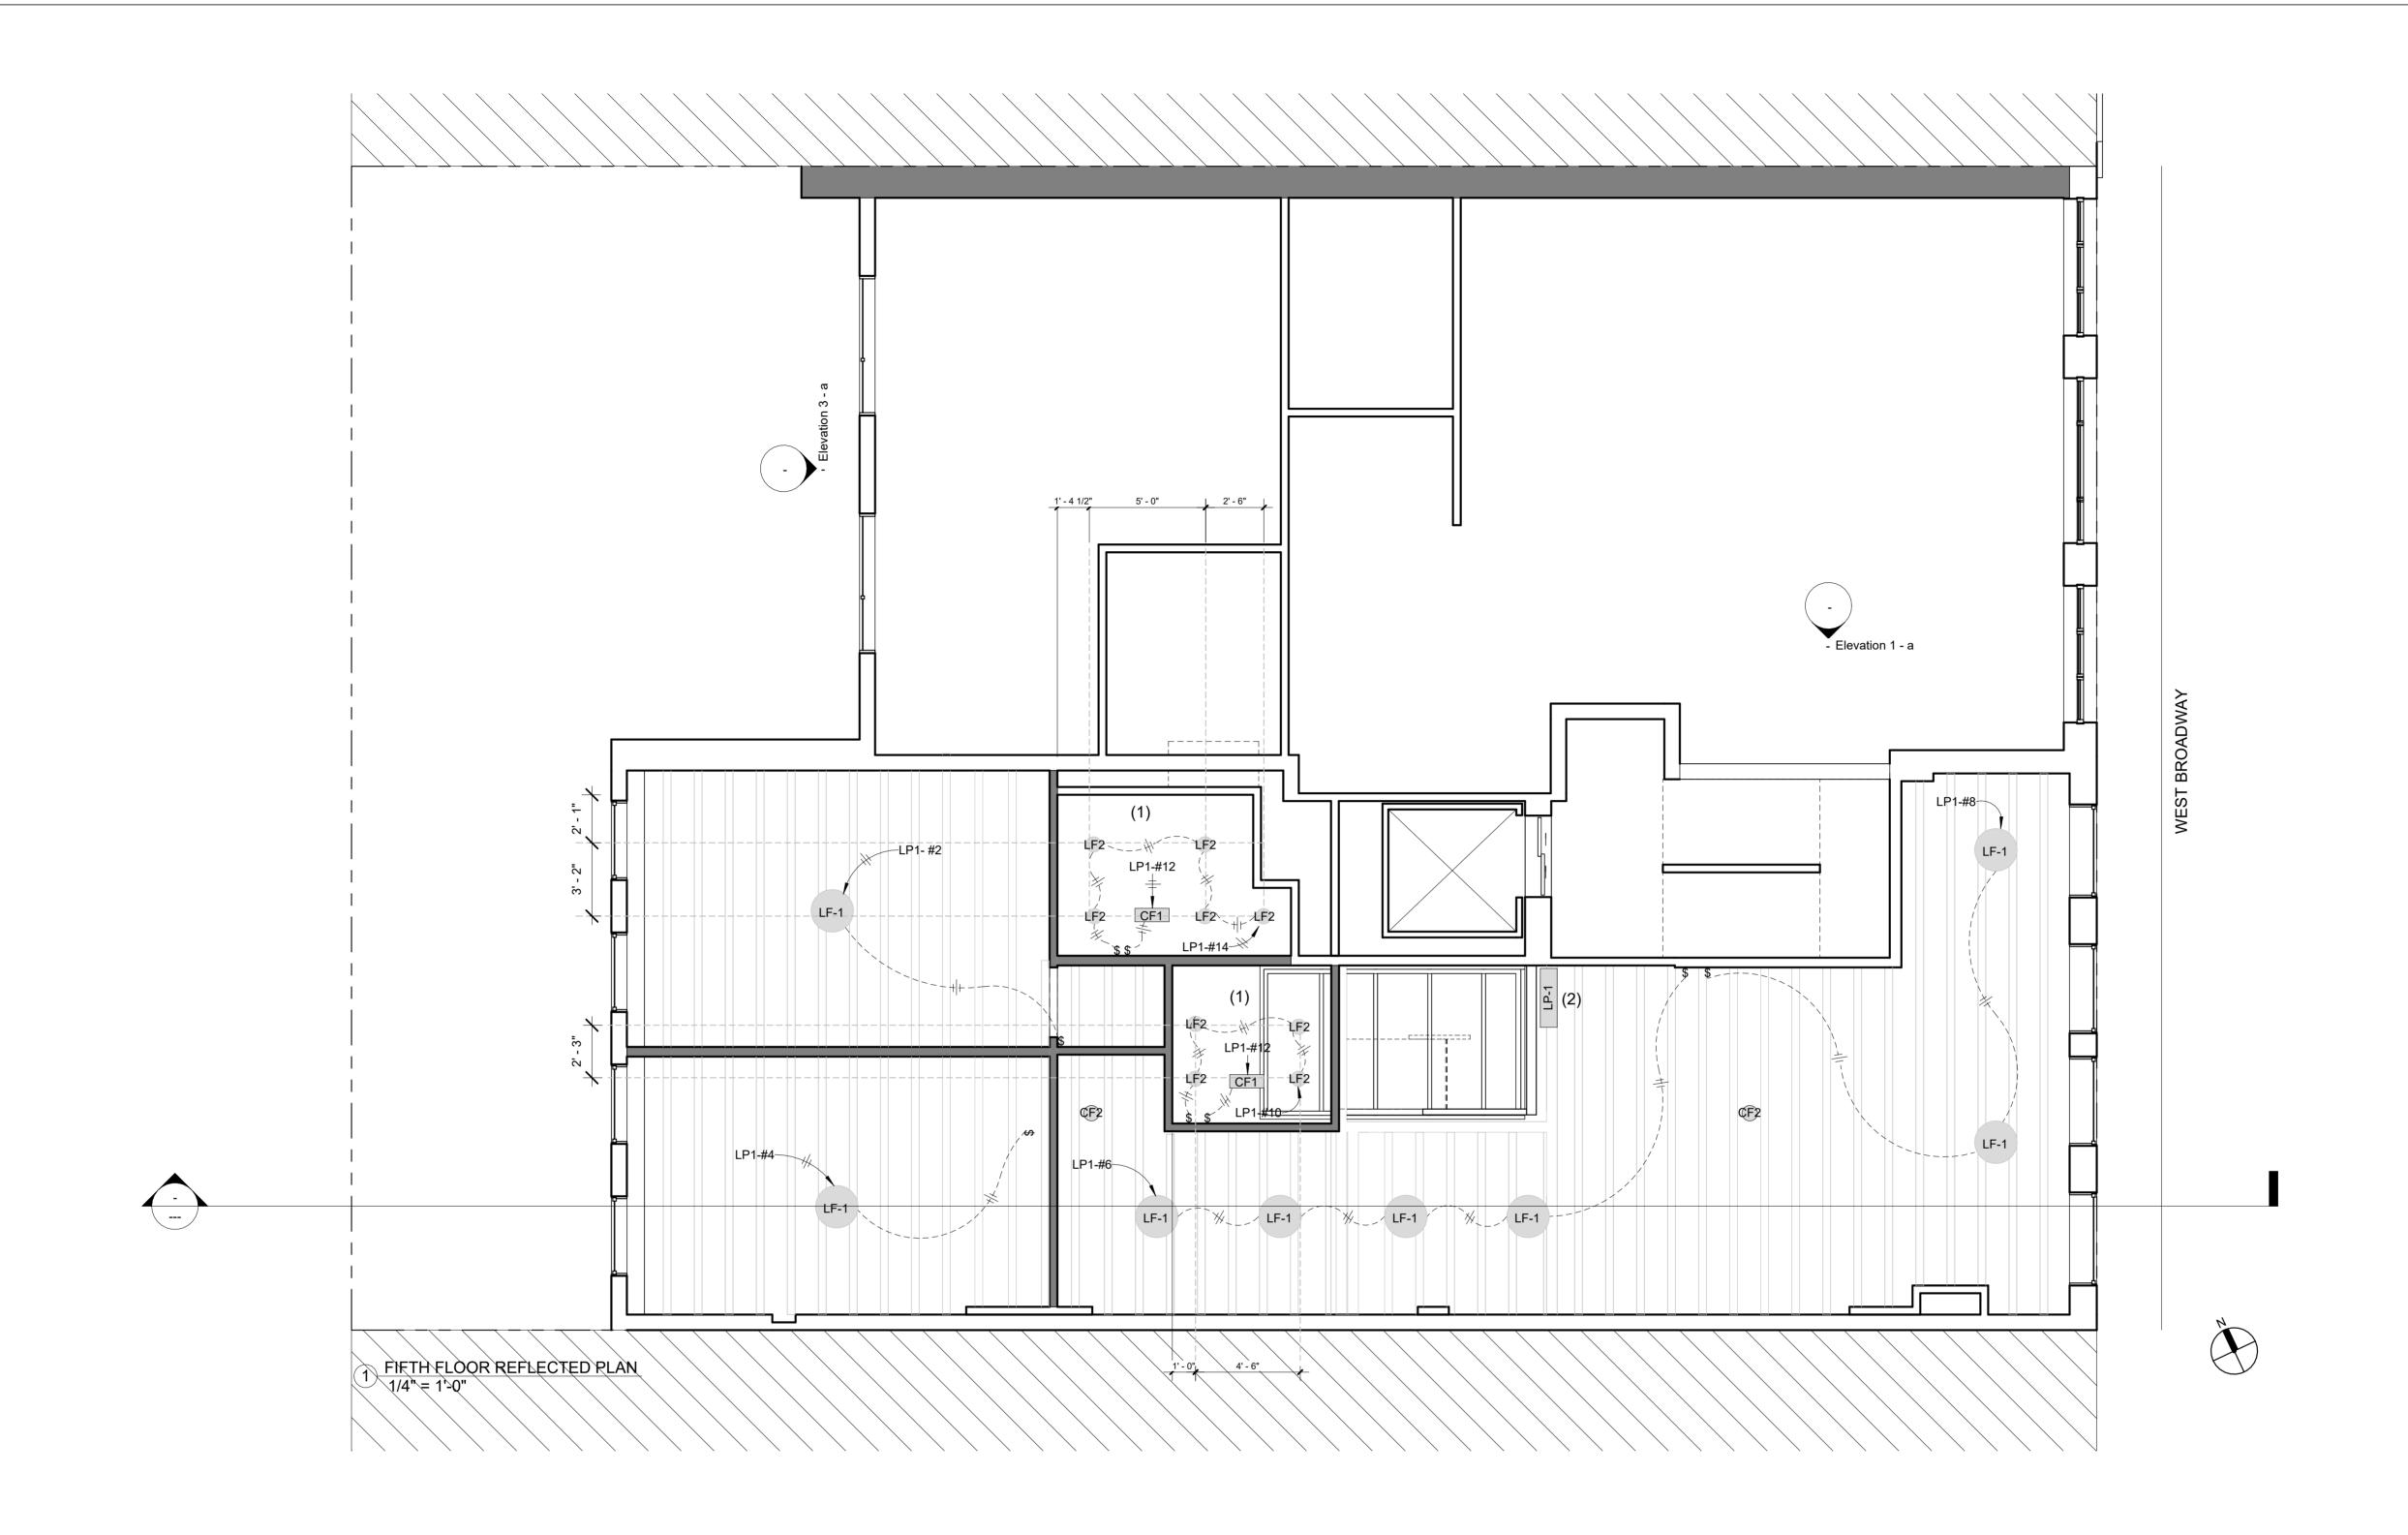

ADDRESS: 460-462 WEST BROADWAY NEW YORK, NY 10012

DATE: 06/23/2022

GROSS FLOOR AREA: 15,204SF

ARCHITECT OF RECORD:

design office

DY-O DESIGN OFFICE 143 WEST 29 STREET NEW YORK, NY 10001 SUITE# 902A

CONTACT: STEFANO MORISI R.A. T: 1-917-960-3961 E: INFO@STUDIODYO.COM

DESIGN ARCHITECT:

Architect Monica Cardin Fontana architetto@cardinfontana.it - www.cardinfontana.it

VIA MARCONI, 43 CASALECCHIO DI RENO, (BO) ARCHITETTO@CARDINFONTANA.IT WWW.CARDINFONTANA.IT

OWNER:

CRISTINA CALORI CCNY REALTY, INC. 444 MADISON AVE **NEW YOR, NY 10022**

DOB JOB #: 120070485

DISCLAIMER:

The architect shall not have control or charge of and shall not be responsible for construction means, methods, deviations, techniques, sequences or procedures, or for safety precautions and programs in connection with the work, for the acts or ommisions of the contractor, sub-contractors, or any other persons performing any of the work, or for the failure of any of them to carry out the work in accordance with the contract documents. written dimensions on this drawing shall have precedence over scaled dimensions. Contractors shall verify and be responsible for all dimensions and conditions on the job and this office must be notified of any variations from the dimensions and conditions shown by these drawings. shop details must be submitted to this office for review before proceeding with fabrication. not valid for construction unless signed and sealed by the architect and

 Rev
 Date
 Description
 Issued By
 Issued To


 1
 12/11/2023
 DOB Submission 1
 DYO
 DOB

approved by the department of buildings.

SHEET TITLE:

5TH FLOOR PROPOSED RCP

SEAL AND SIGNATURE

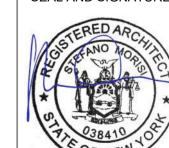

DATE MM/DD/YYYY

DRAWN BY CHECKED BY SM

DYO NO. 220809



1. NEW CEILING FINISHED WITH 2 LAYERS OF GYPSUMBOARD TYPE X 5/8" 2. NEW ELECTRICAL PANEL LOCATED ON 5TH FLOOR

3. EXISTING CEILING TO REMAIN

2.EXISTING LIGHT FIXTURES ON LIVING ROOM TO BE REMOVED 3.LIVING ROOM CEILING TO BE PATCHED

1. EXISTING CEILING TO REMAIN

4.NEW CEILING TO MATCH EXITING CEILING IN HEIGHT

REFLECTED CEILING PLAN FIXTURE SCHEDULE:

COL. TEMP COL. LUMENS DIM. WATTS WATTAGE	COL. TEMP	LOCATION	CRI	VOLTS	CODE	MOD	MFR	TYP.	IMG	ID	SYMBOL
oom 8	n	Bedrooms,Livingroom	EXISTING					LIGHT PENDANT		LF1	
3000 430 LM Dim 6 W	3000	Bathrooms		240		Void 80	Astro	RECESSED LIGHT		LF2	
3000 K 430 LM Dim 6.7 W	3000 K	all other areas	23	240	SLE11-06-025 D-930-03-01	Storm Small Direct	One A	RECESSED LIGHT		LF3	
								EXTRACTOR		CF1	
								SMOKE DITECTOR		CF2	
oom 8 3000 430 LM Dim 6 W	3000	Bedrooms,Livingroom Bathrooms		240	NG SLE11-06-025	EXIST Void 80	Astro	LIGHT PENDANT RECESSED LIGHT RECESSED LIGHT EXTRACTOR	IMG	LF1 LF2 LF3 CF1	STMBOL

DENOTES LIGHT FIXTURES ON SAME CIRCUIT EXIT SIGN OCCUPANT SENSOR CONTROL DAYLIGHT RESPONSIVE CONTROL

MASTER SWITCH OFF

SWITCH CONTROLLING DESIGNATE CIRCUIT


LOCAL SWITCH

DOUBLE SWITCH

DIMMER SWITCH DENOTES CIRCUIT IN NUMBER IN AREA

LEGEND

4. NEW OPENING ON CEILING. G.C TO V.I.F EXACT LOCATION

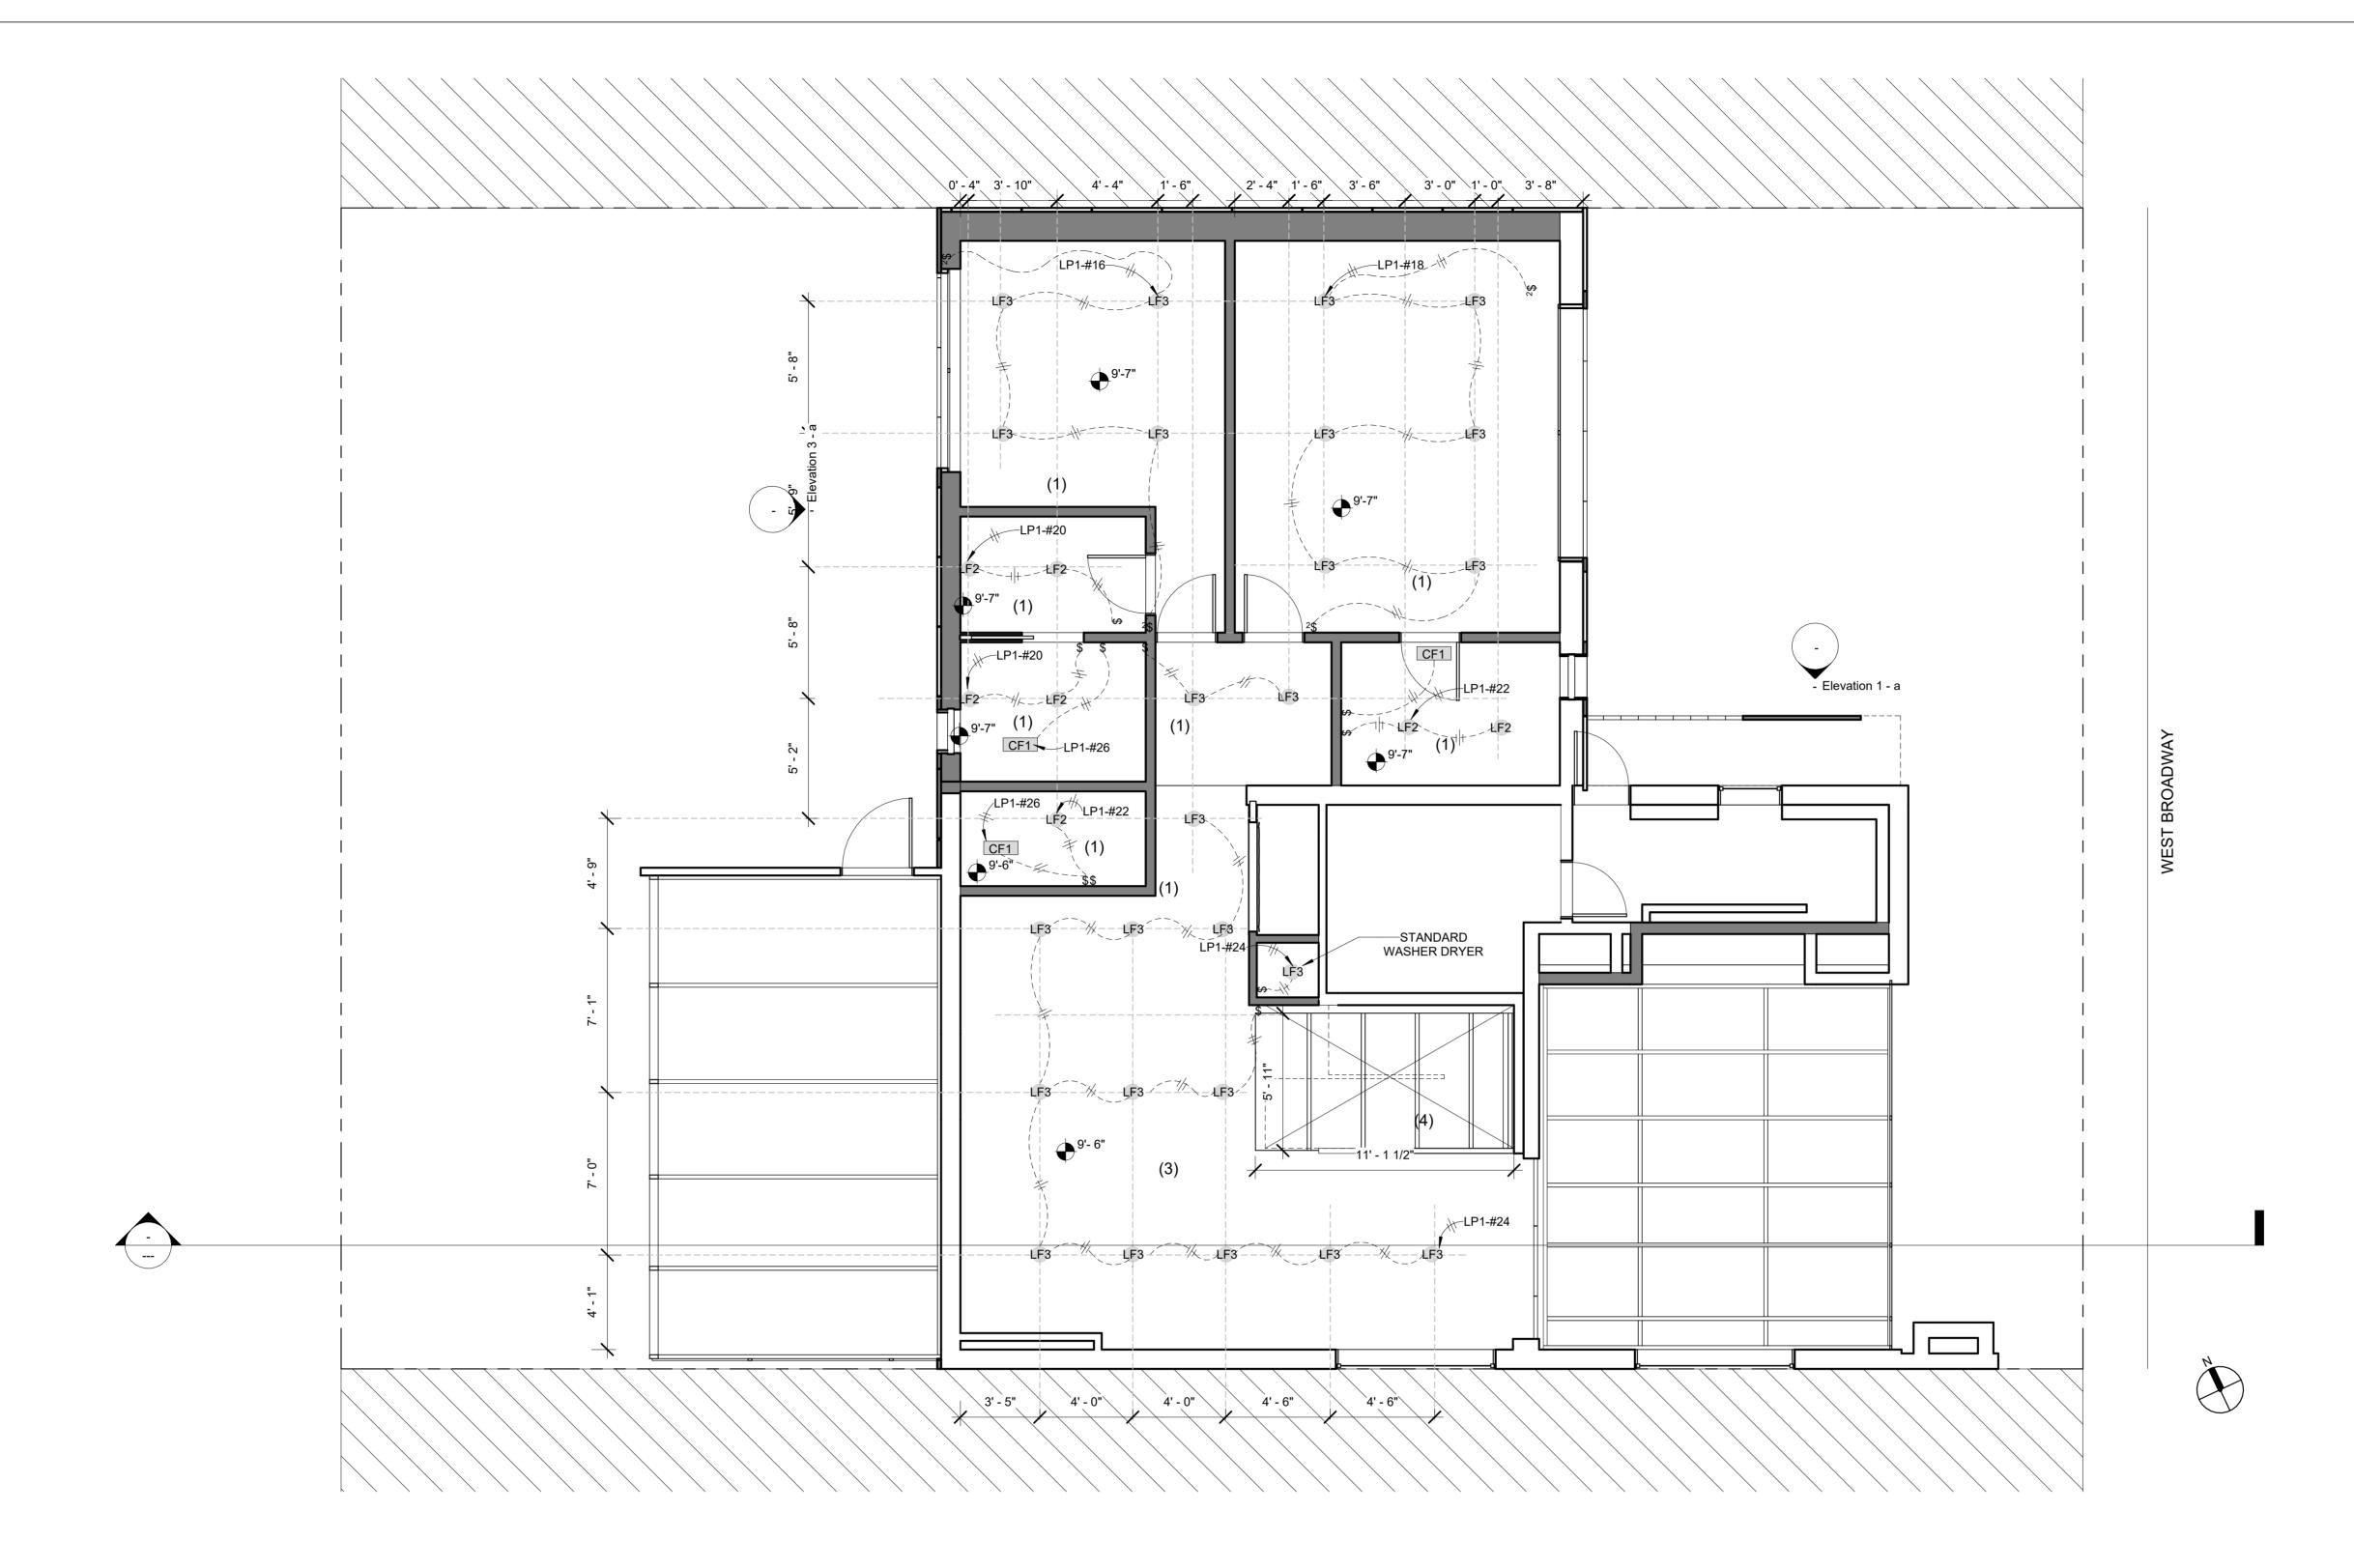



ADDRESS: 460-462 WEST BROADWAY NEW YORK, NY 10012

DATE: 06/23/2022

GROSS FLOOR AREA: 15,204SF

ARCHITECT OF RECORD:

design office

DY-O DESIGN OFFICE 143 WEST 29 STREET NEW YORK, NY 10001 SUITE# 902A

CONTACT: STEFANO MORISI R.A. T: 1-917-960-3961 E: INFO@STUDIODYO.COM

DESIGN ARCHITECT:

Architect Monica Cardin Fontana architetto@cardinfontana.it - www.cardinfontano.it

VIA MARCONI, 43 CASALECCHIO DI RENO, (BO) ARCHITETTO@CARDINFONTANA.IT WWW.CARDINFONTANA.IT

OWNER:

CRISTINA CALORI CCNY REALTY, INC. 444 MADISON AVE NEW YOR, NY 10022

DOB JOB #: 120070485

DISCLAIMER:


The architect shall not have control or charge of and shall not be responsible for construction means, methods, deviations, techniques, sequences or procedures, or for safety precautions and programs in connection with the work, for the acts or ommisions of the contractor, sub-contractors, or any other persons performing any of the work, or for the failure of any of them to carry out the work in accordance with the contract documents. written dimensions on this drawing shall have precedence over scaled dimensions. Contractors shall verify and be responsible for all dimensions and conditions on the job and this office must be notified of any variations from the dimensions and conditions shown by these drawings. shop details must be submitted to this office for review before proceeding with fabrication. not valid for construction unless signed and sealed by the architect and approved by the department of buildings.

 Rev
 Date
 Description
 Issued By
 Issued To

 1
 12/11/2023
 DOB Submission 1
 DYO
 DOB

SHEET TITLE:

6TH FLOOR PROPOSED RCP

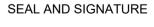



DRAWN BY CHECKED BY SM

DATE MM/DD/YYYY

DYO NO. 220809



2. NEW ELECTRICAL PANEL LOCATED ON 5TH FLOOR

3. EXISTING CEILING TO REMAIN 4. NEW OPENING ON CEILING. G.C TO V.I.F EXACT LOCATION

REFLECTED CEILING PLAN FIXTURE SCHEDULE:

SYMBOL	ID	IMG	TYP.	MFR	MOD	CODE	VOLTS	CRI	LOCATION	COL. TEMP	QTY	LUMENS	DIM.	WATTS	TOTAL WATTAGE
	LF1		LIGHT PENDANT	EXISTING					Bedrooms,Livingroom		8				
	LF2		RECESSED LIGHT	Astro	Void 80		240		Bathrooms	3000		430 LM	Dim	6 W	
	LF3		RECESSED LIGHT	One A	Storm Small Direct	SLE11-06-025 D-930-03-01	240	23	all other areas	3000 K		430 LM	Dim	6.7 W	
	CF1		EXTRACTOR												
	CF2		SMOKE DITECTOR										·	·	
								•							

LEGEND

IN NUMBER IN AREA DENOTES LIGHT FIXTURES ON SAME CIRCUIT **EXIT SIGN** OCCUPANT SENSOR CONTROL DAYLIGHT RESPONSIVE CONTROL

MASTER SWITCH OFF

SWITCH CONTROLLING

DESIGNATE CIRCUIT

LOCAL SWITCH


DOUBLE SWITCH

DIMMER SWITCH DENOTES CIRCUIT

2.EXISTING LIGHT FIXTURES ON LIVING ROOM TO BE REMOVED 3.LIVING ROOM CEILING TO BE PATCHED

1. NEW CEILING FINISHED WITH 2 LAYERS OF GYPSUMBOARD TYPE X 5/8" 1. EXISTING CEILING TO REMAIN

4.NEW CEILING TO MATCH EXITING CEILING IN HEIGHT

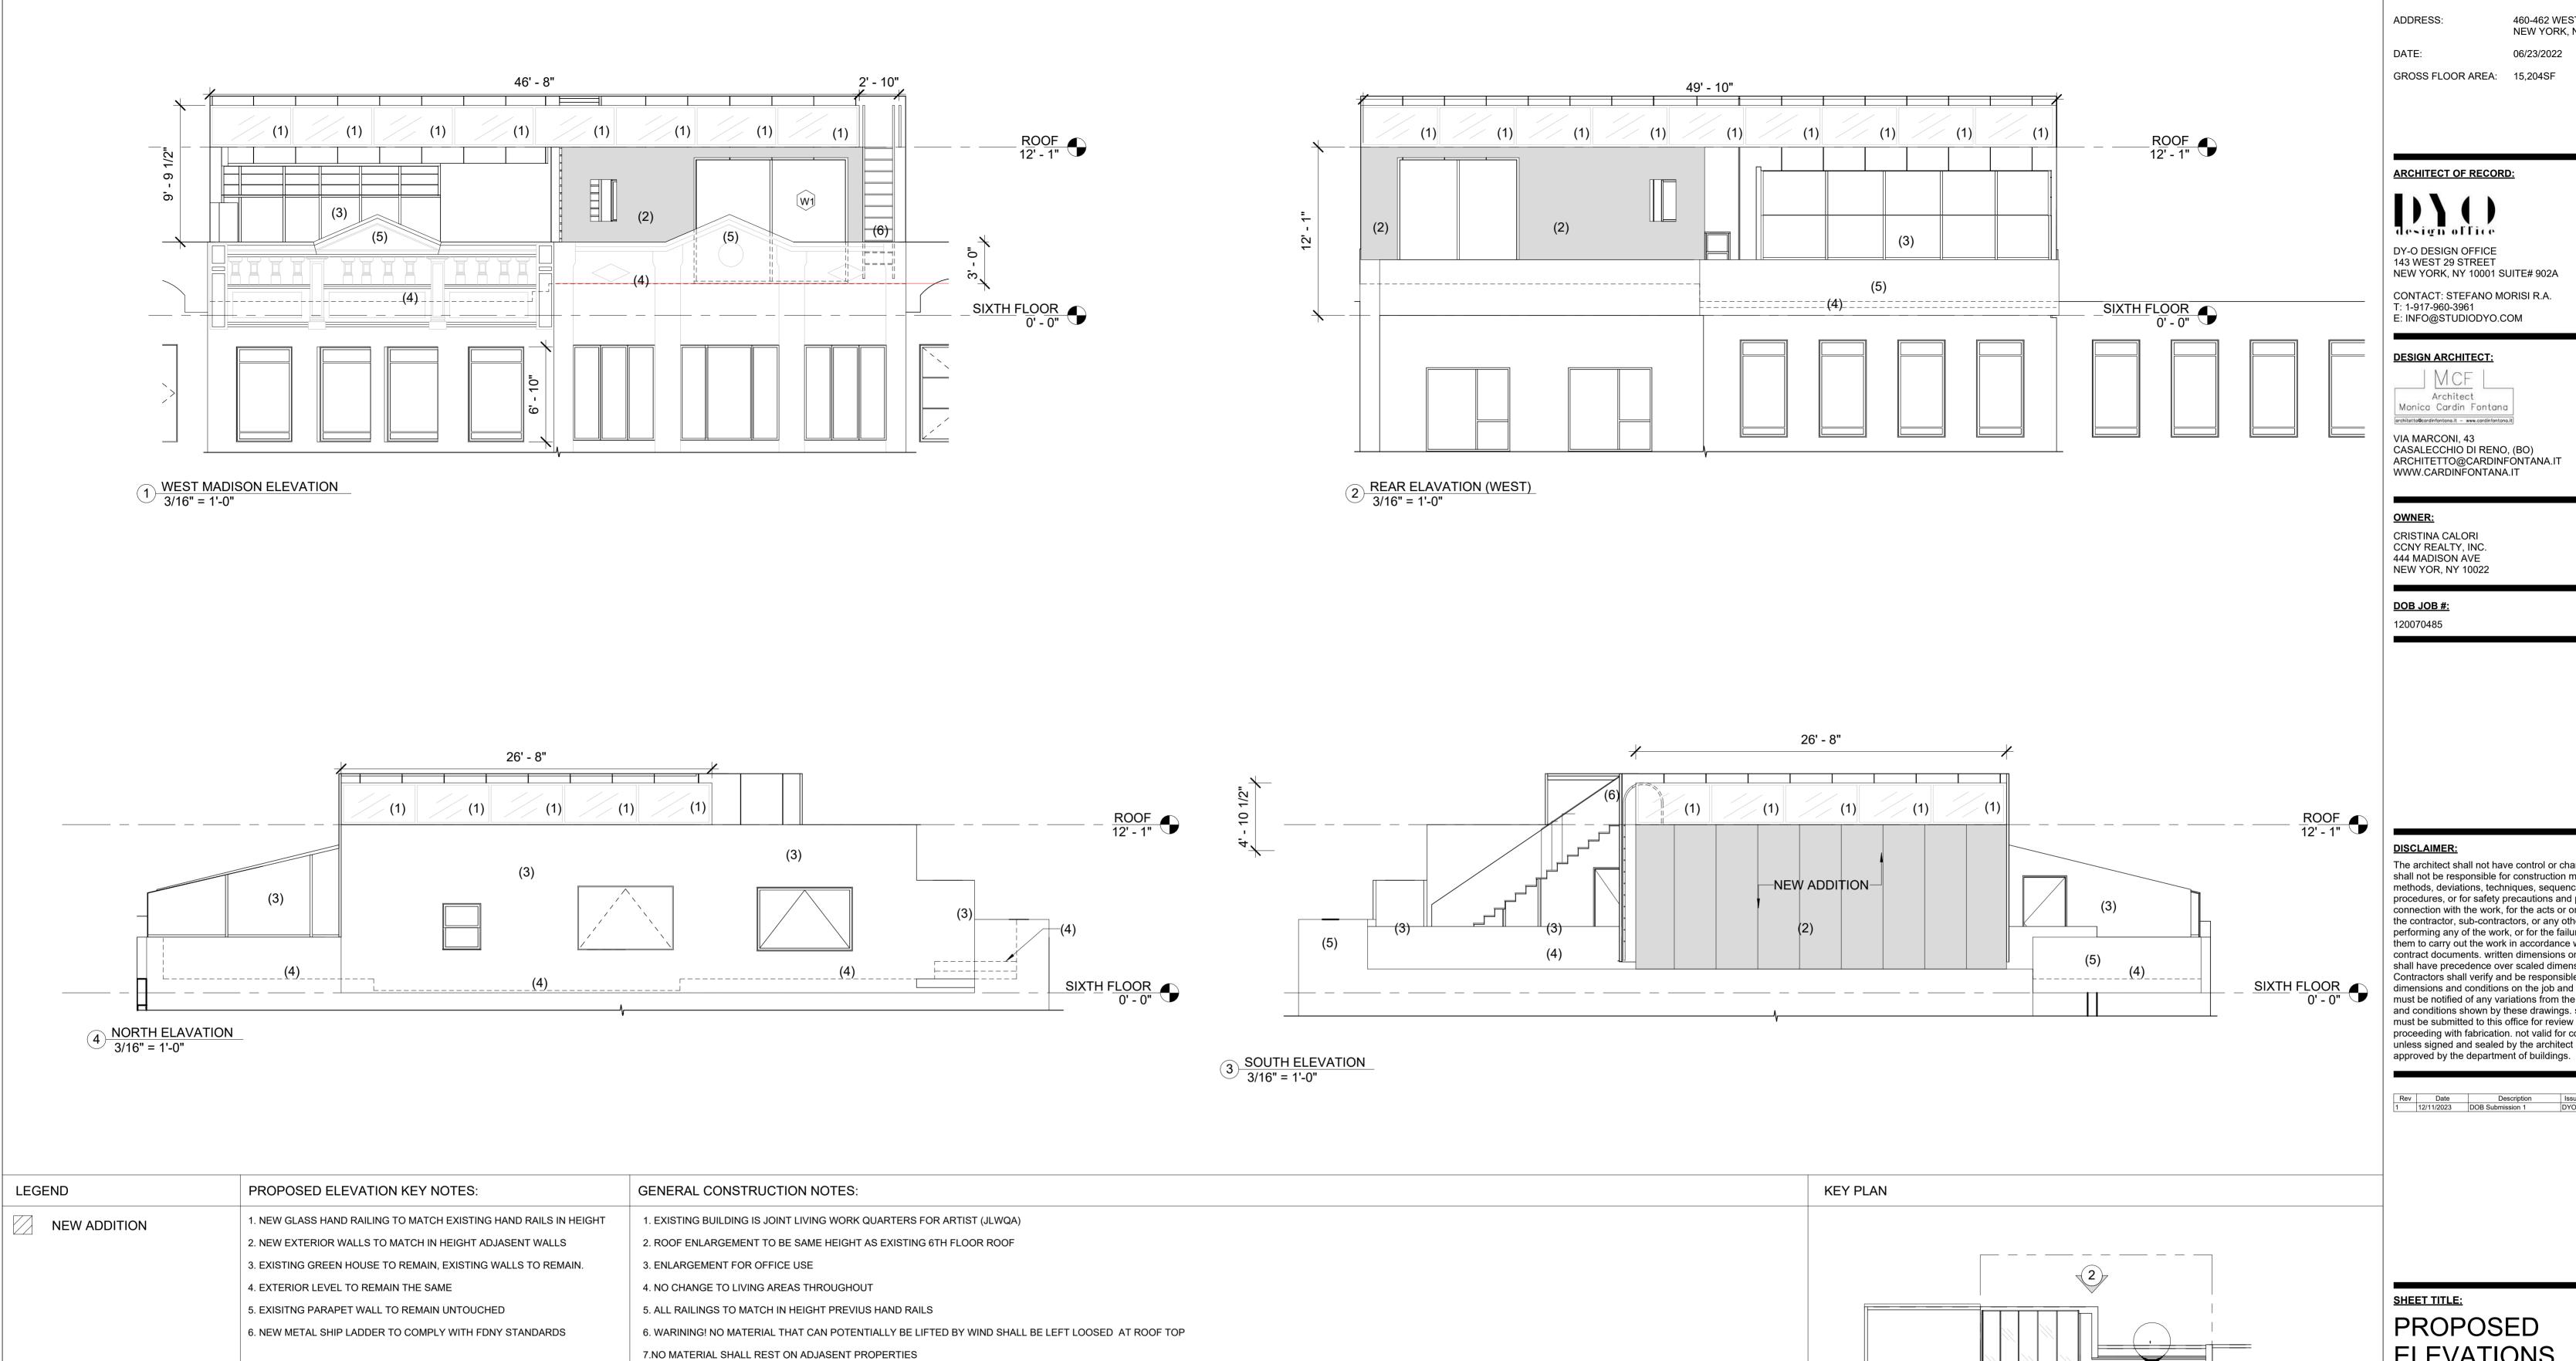

460-462 WEST BROADWAY NEW YORK, NY 10012

06/23/2022

ARCHITECT OF RECORD:

PROJECT INFORMATION:

DY-O DESIGN OFFICE 143 WEST 29 STREET NEW YORK, NY 10001 SUITE# 902A

CONTACT: STEFANO MORISI R.A.

Architect Monica Cardin Fontana

VIA MARCONI, 43 CASALECCHIO DI RENO, (BO)
ARCHITETTO@CARDINFONTANA.IT
WWW.CARDINFONTANA.IT

CCNY REALTY, INC.

The architect shall not have control or charge of and shall not be responsible for construction means, methods, deviations, techniques, sequences or procedures, or for safety precautions and programs in connection with the work, for the acts or ommisions of the contractor, sub-contractors, or any other persons performing any of the work, or for the failure of any of them to carry out the work in accordance with the contract documents. written dimensions on this drawing shall have precedence over scaled dimensions. Contractors shall verify and be responsible for all dimensions and conditions on the job and this office must be notified of any variations from the dimensions and conditions shown by these drawings. shop details must be submitted to this office for review before proceeding with fabrication. not valid for construction unless signed and sealed by the architect and

 Rev
 Date
 Description
 Issued By
 Issued To

 1
 12/11/2023
 DOB Submission 1
 DYO
 DOB

PROPOSED **ELEVATIONS**

SEAL AND SIGNATURE

Elevation 3 - a


3

WEST BROADWAY

NEW ADDITION



DATE MM/DD/YYYY DRAWN BY CHECKED BY

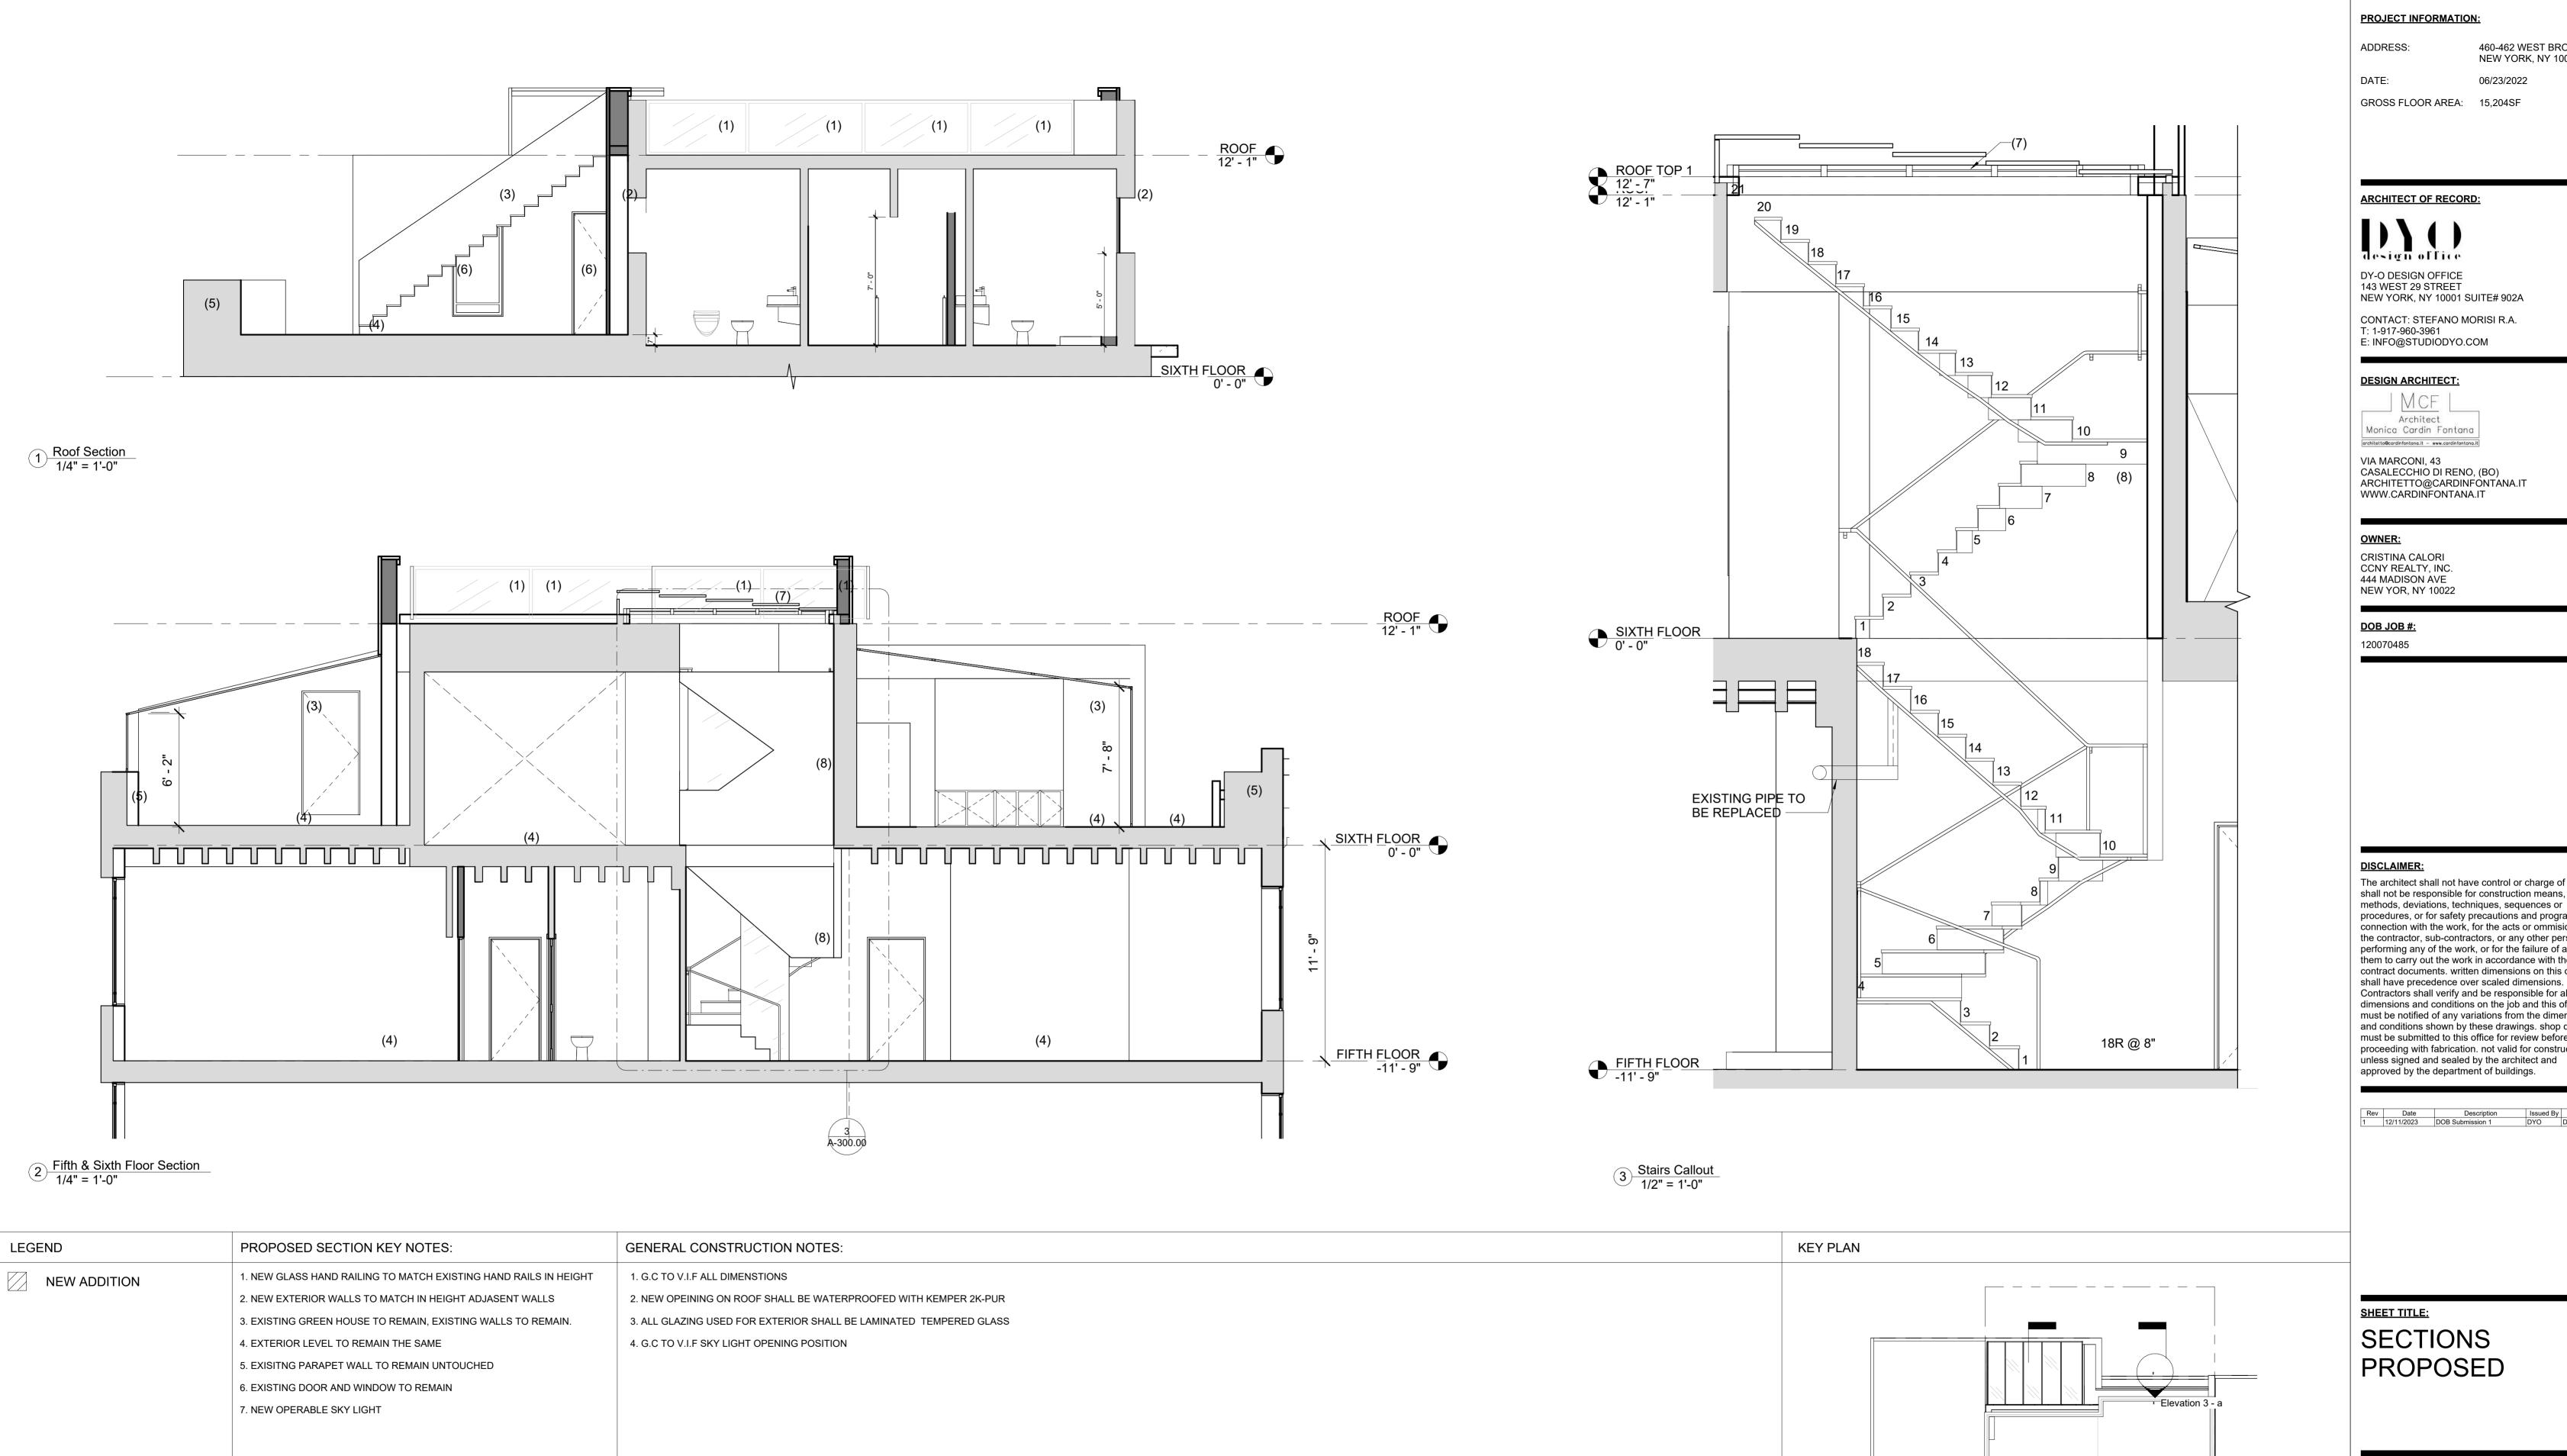

460-462 WEST BROADWAY NEW YORK, NY 10012 ADDRESS:

DATE: 06/23/2022 GROSS FLOOR AREA: 15,204SF

DY-O DESIGN OFFICE 143 WEST 29 STREET NEW YORK, NY 10001 SUITE# 902A

CONTACT: STEFANO MORISI R.A. T: 1-917-960-3961 E: INFO@STUDIODYO.COM

DESIGN ARCHITECT:

Architect Monica Cardin Fontana architetto@cardinfontana.lt - www.cardinfontano.ii

VIA MARCONI, 43 CASALECCHIO DI RENO, (BO)
ARCHITETTO@CARDINFONTANA.IT
WWW.CARDINFONTANA.IT

OWNER:

CRISTINA CALORI CCNY REALTY, INC. 444 MADISON AVE **NEW YOR, NY 10022**

DOB JOB #: 120070485

DISCLAIMER:

The architect shall not have control or charge of and shall not be responsible for construction means, methods, deviations, techniques, sequences or procedures, or for safety precautions and programs in connection with the work, for the acts or ommisions of the contractor, sub-contractors, or any other persons performing any of the work, or for the failure of any of them to carry out the work in accordance with the contract documents. written dimensions on this drawing shall have precedence over scaled dimensions. Contractors shall verify and be responsible for all dimensions and conditions on the job and this office must be notified of any variations from the dimensions and conditions shown by these drawings. shop details must be submitted to this office for review before proceeding with fabrication. not valid for construction

 Rev
 Date
 Description
 Issued By
 Issued To

 1
 12/11/2023
 DOB Submission 1
 DYO
 DOB

SHEET TITLE:

SECTIONS PROPOSED


SEAL AND SIGNATURE




DRAWN BY CHECKED BY


DYO NO. 220809

DATE MM/DD/YYYY

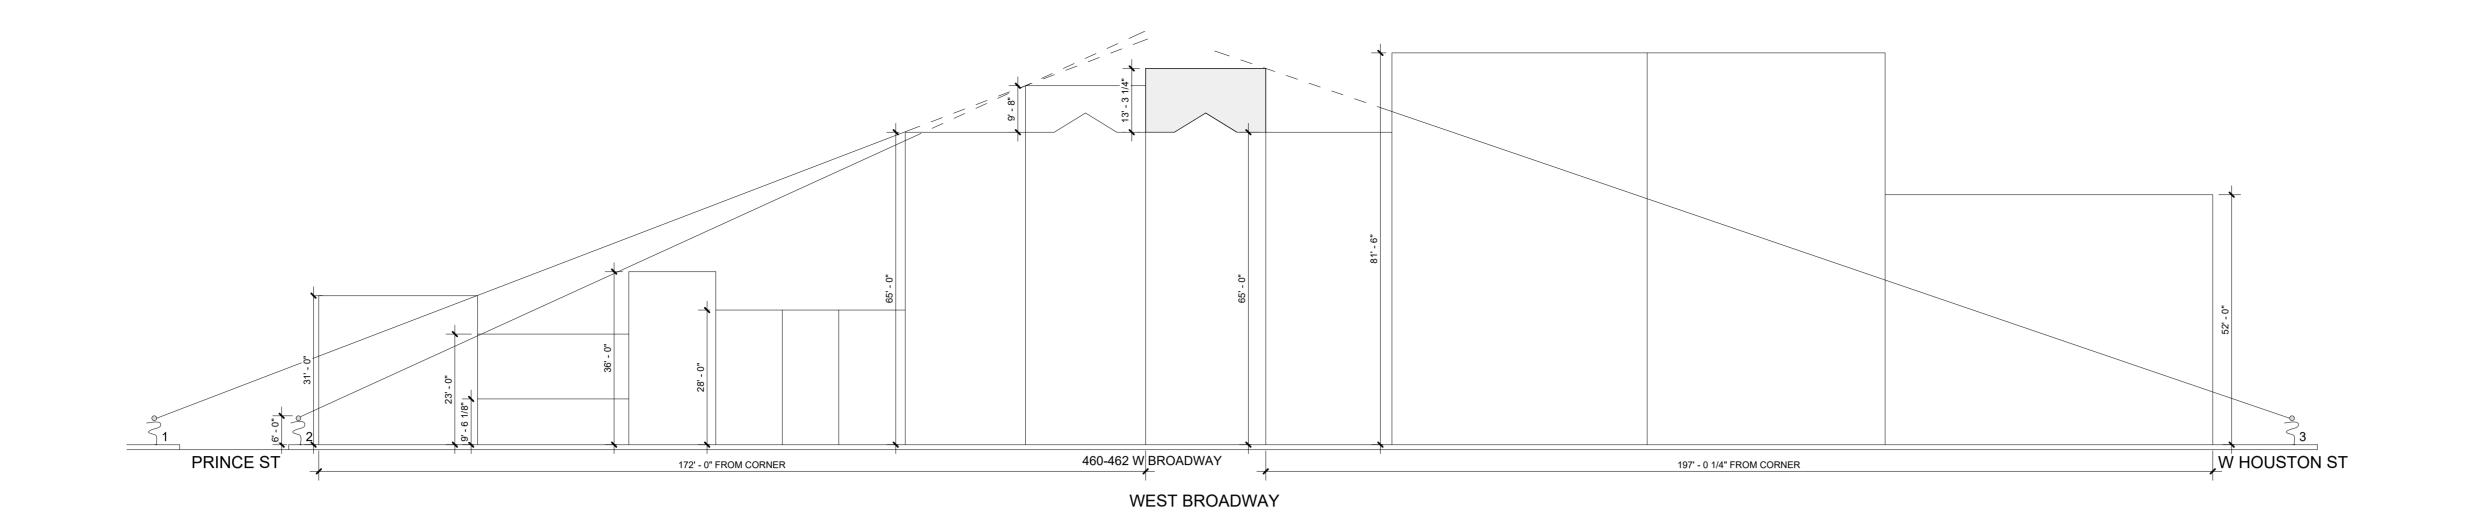


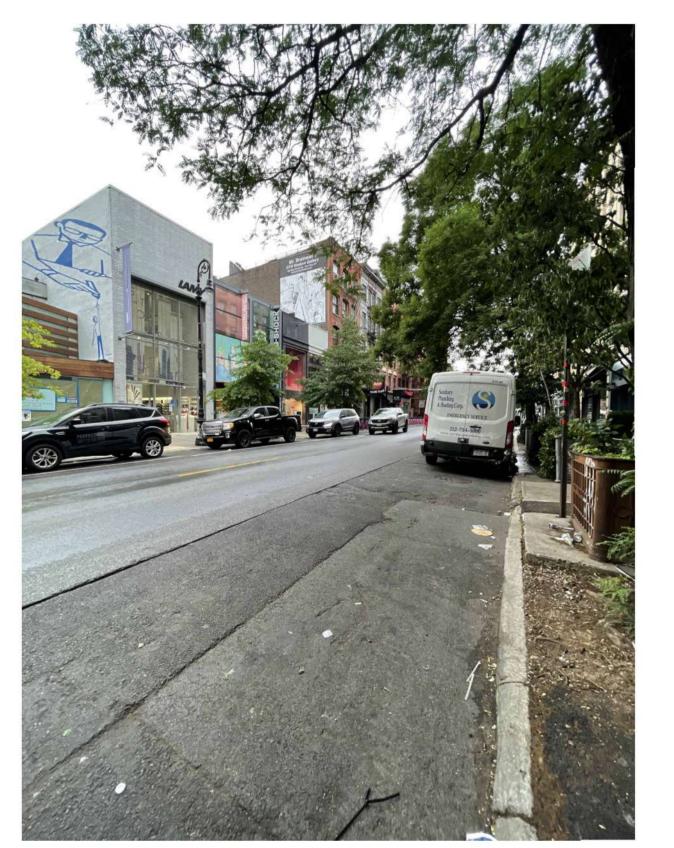


<u>VIEW 1</u>: EXISTING VIEW FROM PRINCE ST CORNER

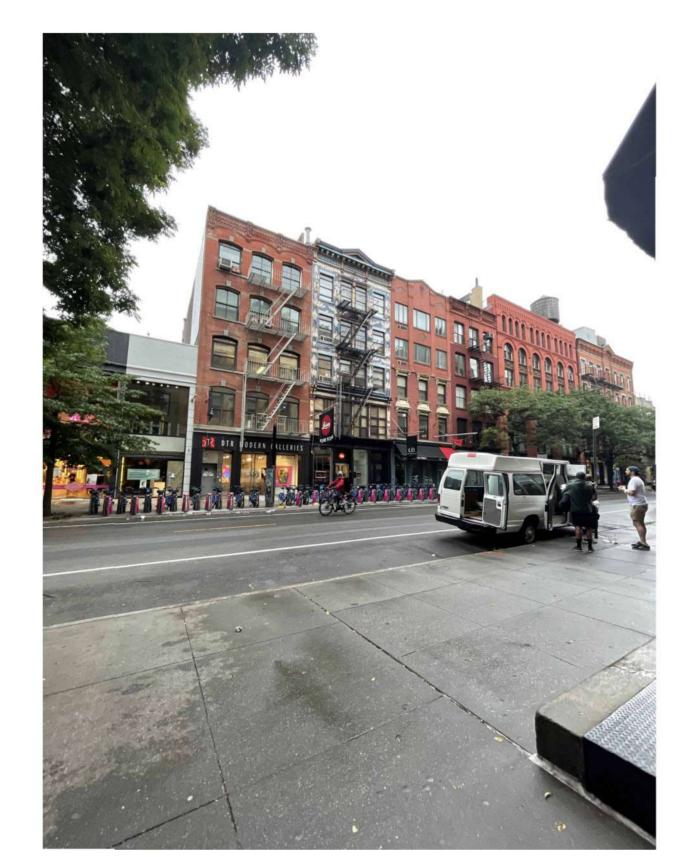

VIEW 2: EXISTING VIEW FROM PRINCE ST CORNER

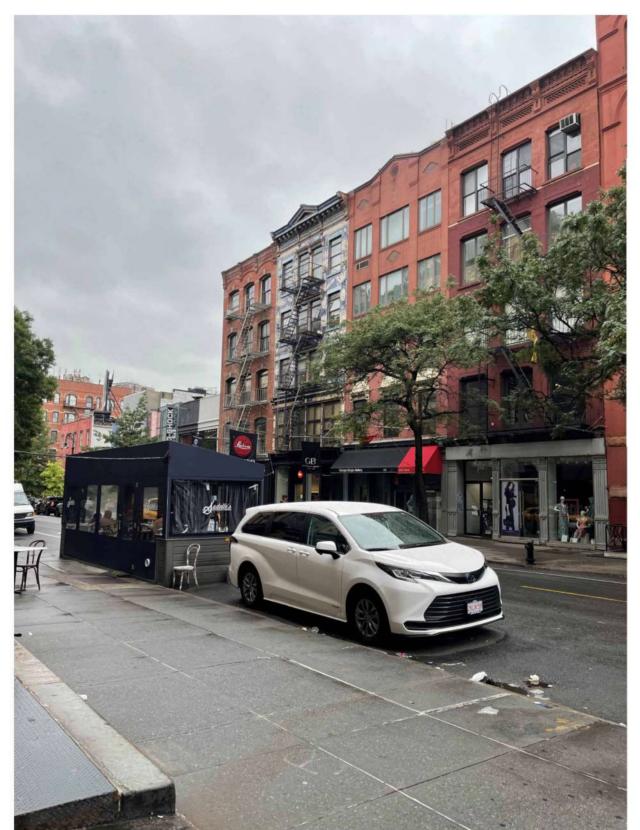

VIEW 3: EXISTING VIEW FROM WEST HOUSTON ST CORNER

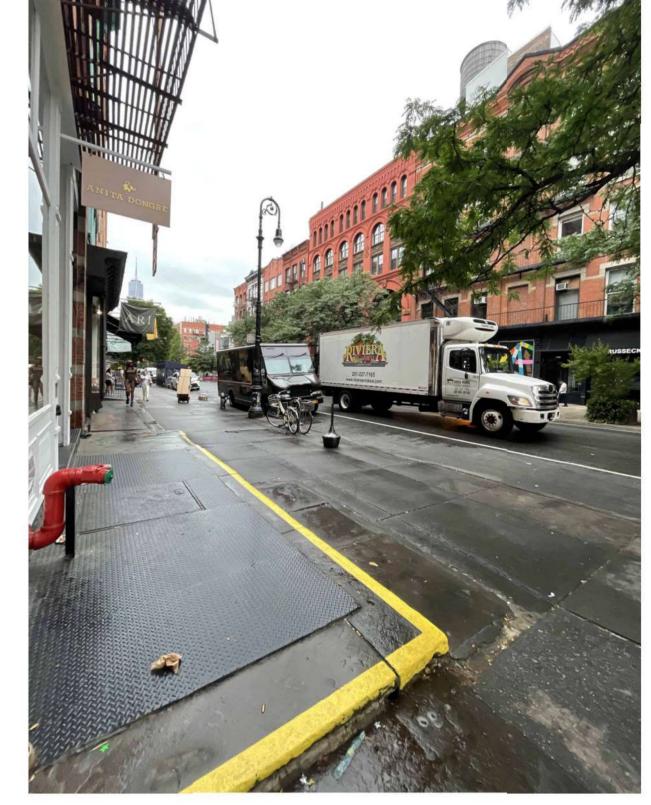

VIEW 4: EXISTING VIEW FROM WEST HOUSTON ST CORNER



VIEW 1: PROPOSED VIEW FROM PRINCE ST CORNER



VIEW 2: PROPOSED VIEW FROM PRINCE ST CORNER



VIEW 3: PROPOSED VIEW FROM WEST HOUSTON ST CORNER



VIEW 4: PROPOSED VIEW FROM WEST HOUSTON ST CORNER

ADDRESS: 460-462 WEST BROADWAY NEW YORK, NY 10012

DATE: 06/23/2022

GROSS FLOOR AREA: 15,204SF

ARCHITECT OF RECORD:

design office

DY-O DESIGN OFFICE 143 WEST 29 STREET NEW YORK, NY 10001 SUITE# 902A

CONTACT: STEFANO MORISI R.A. T: 1-917-960-3961 E: INFO@STUDIODYO.COM

DESIGN ARCHITECT:

Architect

Monica Cardin Fontana

architetto@cordinfontana.it - www.cardinfontana.it

VIA MARCONI, 43 CASALECCHIO DI RENO, (BO) ARCHITETTO@CARDINFONTANA.IT WWW.CARDINFONTANA.IT

OWNER:

CRISTINA CALORI CCNY REALTY, INC. 444 MADISON AVE NEW YOR, NY 10022

DOB JOB #: 120070485

DISCLAIMER:

DISCLAIMER:


The architect shall not have control or charge of and shall not be responsible for construction means, methods, deviations, techniques, sequences or procedures, or for safety precautions and programs in connection with the work, for the acts or ommisions of the contractor, sub-contractors, or any other persons performing any of the work, or for the failure of any of them to carry out the work in accordance with the contract documents. written dimensions on this drawing shall have precedence over scaled dimensions. Contractors shall verify and be responsible for all dimensions and conditions on the job and this office must be notified of any variations from the dimensions and conditions shown by these drawings. shop details must be submitted to this office for review before proceeding with fabrication. not valid for construction unless signed and sealed by the architect and approved by the department of buildings.

 Rev
 Date
 Description
 Issued By
 Issued To

 1
 12/11/2023
 DOB Submission 1
 DYO
 DOB

SHEET TITLE:

SIGHTLINE

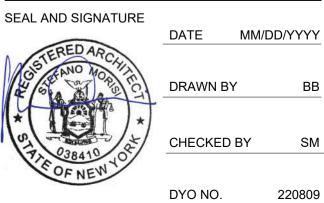

\-700.00

SHEET **21** 0





460-462 WEST BROADWAY NEW YORK, NY 10012 ADDRESS:

DATE: 06/23/2022

GROSS FLOOR AREA: 15,204SF

ARCHITECT OF RECORD:



DY-O DESIGN OFFICE 143 WEST 29 STREET NEW YORK, NY 10001 SUITE# 902A

CONTACT: STEFANO MORISI R.A. T: 1-917-960-3961 E: INFO@STUDIODYO.COM

DESIGN ARCHITECT:



architetta@cardinfontana.it - www.cardinfontana.it VIA MARCONI, 43

CASALECCHIO DI RENO, (BO)
ARCHITETTO@CARDINFONTANA.IT
WWW.CARDINFONTANA.IT

CRISTINA CALORI CCNY REALTY, INC. 444 MADISON AVE **NEW YOR, NY 10022**

DOB JOB #: 120070485

DISCLAIMER:

The architect shall not have control or charge of and shall not be responsible for construction means, methods, deviations, techniques, sequences or procedures, or for safety precautions and programs in connection with the work, for the acts or ommisions of the contractor, sub-contractors, or any other persons performing any of the work, or for the failure of any of them to carry out the work in accordance with the contract documents. written dimensions on this drawing shall have precedence over scaled dimensions.
Contractors shall verify and be responsible for all dimensions and conditions on the job and this office must be notified of any variations from the dimensions and conditions shown by these drawings. shop details must be submitted to this office for review before proceeding with fabrication. not valid for construction unless signed and sealed by the architect and approved by the department of buildings.

 Rev
 Date
 Description
 Issued By
 Issued To

 1
 12/11/2023
 DOB Submission 1
 DYO
 DOB

SHEET TITLE:

ROOFTOP RENDERS

SEAL AND SIGNATURE



DRAWN BY

CHECKED BY SM

DATE MM/DD/YYYY

DYO NO. 220809

ର୍ଚ୍ଚ | WEST MADISON VIEW





ADDRESS: 460-462 WEST BROADWAY NEW YORK, NY 10012

DATE: 06/23/2022

GROSS FLOOR AREA: 15,204SF

ARCHITECT OF RECORD:

DY-O DESIGN OFFICE 143 WEST 29 STREET NEW YORK, NY 10001 SUITE# 902A

CONTACT: STEFANO MORISI R.A. T: 1-917-960-3961 E: INFO@STUDIODYO.COM

DESIGN ARCHITECT:

Architect Monica Cardin Fontana

VIA MARCONI, 43 CASALECCHIO DI RENO, (BO)
ARCHITETTO@CARDINFONTANA.IT
WWW.CARDINFONTANA.IT

OWNER:

CRISTINA CALORI CCNY REALTY, INC. 444 MADISON AVE NEW YOR, NY 10022

DOB JOB #: 120070485

DISCLAIMER:


The architect shall not have control or charge of and shall not be responsible for construction means, methods, deviations, techniques, sequences or procedures, or for safety precautions and programs in connection with the work, for the acts or ommisions of the contractor, sub-contractors, or any other persons performing any of the work, or for the failure of any of them to carry out the work in accordance with the contract documents. written dimensions on this drawing shall have precedence over scaled dimensions. Contractors shall verify and be responsible for all dimensions and conditions on the job and this office must be notified of any variations from the dimensions and conditions shown by these drawings. shop details must be submitted to this office for review before proceeding with fabrication. not valid for construction unless signed and sealed by the architect and approved by the department of buildings.

 Rev
 Date
 Description
 Issued By
 Issued To

 1
 12/11/2023
 DOB Submission 1
 DYO
 DOB

SHEET TITLE:

ROOFTOP RENDERS

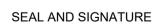



DRAWN BY


CHECKED BY SM


DATE MM/DD/YYYY

DYO NO. 220809

NORTH EAST VIEW

് NORTH WEST VIEW

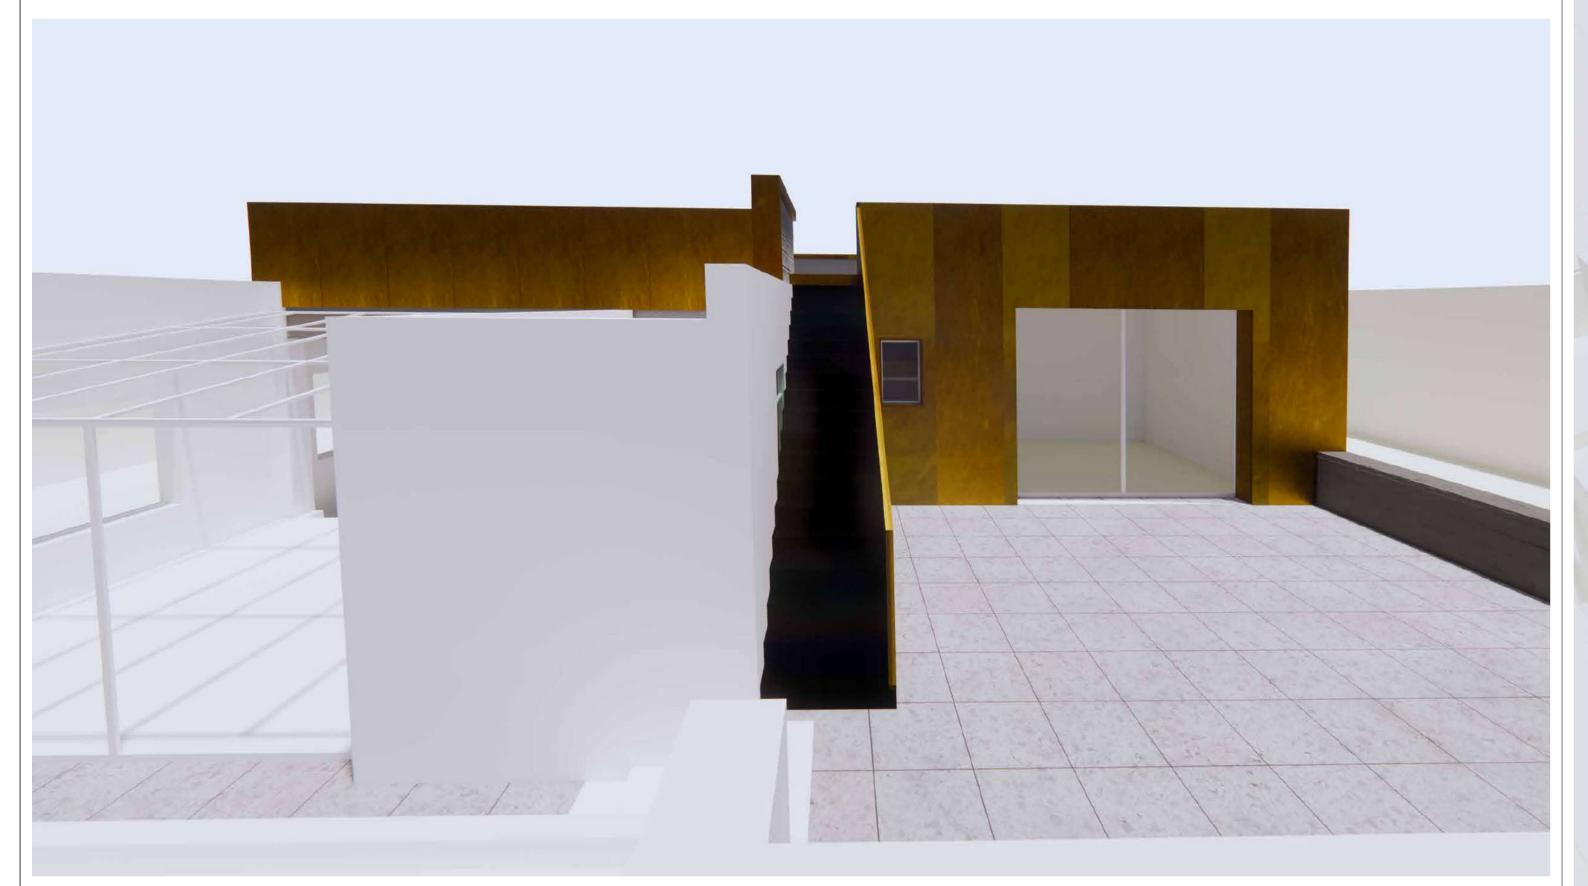

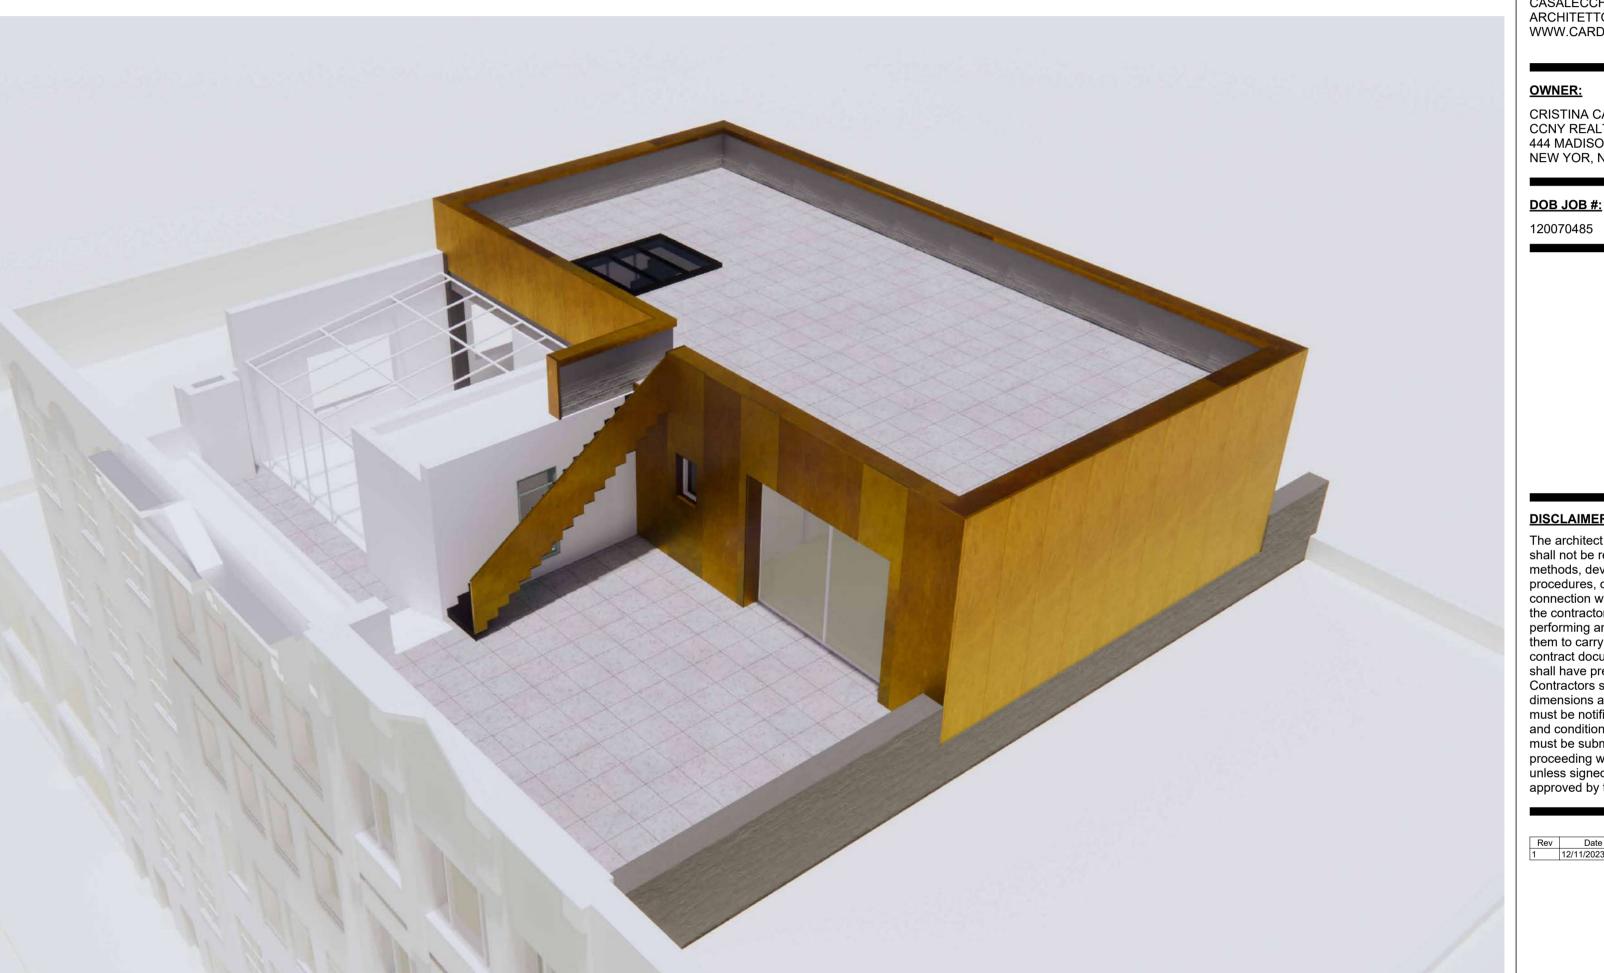

460-462 WEST BROADWAY NEW YORK, NY 10012 ADDRESS:

DATE: 06/23/2022

GROSS FLOOR AREA: 15,204SF

ARCHITECT OF RECORD:



DY-O DESIGN OFFICE 143 WEST 29 STREET NEW YORK, NY 10001 SUITE# 902A

CONTACT: STEFANO MORISI R.A. T: 1-917-960-3961 E: INFO@STUDIODYO.COM

DESIGN ARCHITECT:

MCF Architect Monica Cardin Fontana

architetto@cardinfontana.it - www.cardinfontana.it

VIA MARCONI, 43 CASALECCHIO DI RENO, (BO)
ARCHITETTO@CARDINFONTANA.IT
WWW.CARDINFONTANA.IT

OWNER:

CRISTINA CALORI CCNY REALTY, INC. 444 MADISON AVE NEW YOR, NY 10022

DOB JOB #:

DISCLAIMER:

The architect shall not have control or charge of and shall not be responsible for construction means, methods, deviations, techniques, sequences or procedures, or for safety precautions and programs in connection with the work, for the acts or ommisions of the contractor, sub-contractors, or any other persons performing any of the work, or for the failure of any of them to carry out the work in accordance with the contract documents. written dimensions on this drawing shall have precedence over scaled dimensions. Contractors shall verify and be responsible for all dimensions and conditions on the job and this office must be notified of any variations from the dimensions and conditions shown by these drawings. shop details must be submitted to this office for review before proceeding with fabrication. not valid for construction unless signed and sealed by the architect and approved by the department of buildings.

 Rev
 Date
 Description
 Issued By
 Issued To

 1
 12/11/2023
 DOB Submission 1
 DYO
 DOB

SHEET TITLE:

ROOFTOP RENDERS

SEAL AND SIGNATURE



DRAWN BY

CHECKED BY SM

DATE MM/DD/YYYY

DYO NO. 220809

ল WEST MADISON VIEW

SOUTH WEST VIEW